

GO	
OWER STREET	
SUPPLY AND EXTRACT DUCTS DROP TB. — SUPPLY ATTENUATOR INSTALLED ON VERTICAL DROP.	ATT/AHU01/04/01
SUPPLY AND EXTRACT PENETRATIONS ON WEST WING FOR CONTINUATION, SEE LH0527_LO_LM_M_UPN016_003. SUPPLY & EXTRACT ATTENUATORS TO BE INSTALLED ON VERTICAL DROP.	ATT/AHU01/04/02
CONDENSE DRAINS TO BE RUN TO SAFE LOCATION TO DISCHARGE.	
NEW HAND RAIL AND CAT	PLANT OUT OF SCOPE
AHU 02 REPLACE	
STEEL PLATFORM	ASHP 09
800x800 EXTRACT DUCT SET DOWN AND TRANSFORM TO 800x700.	A A ASH
SUPPLY AND EXTRACT DUCT	
AHU 01 REPLACE ————————————————————————————————————	
1600X500 EXHAUST DUCT CONN ON TOP OF UNIT. DUCT TO RETURN WITH ATTENUATOR ABOVE.	- 1400 - ATT/AHU01/04/04
SEE SECTION AA. FAI DUCT 1000X600 TO BE ROUTED BETWEEN EXISTING SERVICES AT LL TURN 90 DEGREES WITH ATTENUATOR ON RISE.	ATT/AHU01/04/03 A
G	PLANT OUT OF SCOPE
GOWER S	
K	
3	
$\hat{\mathbf{O}}$	

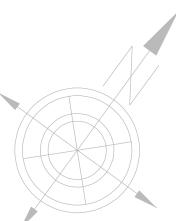

A0

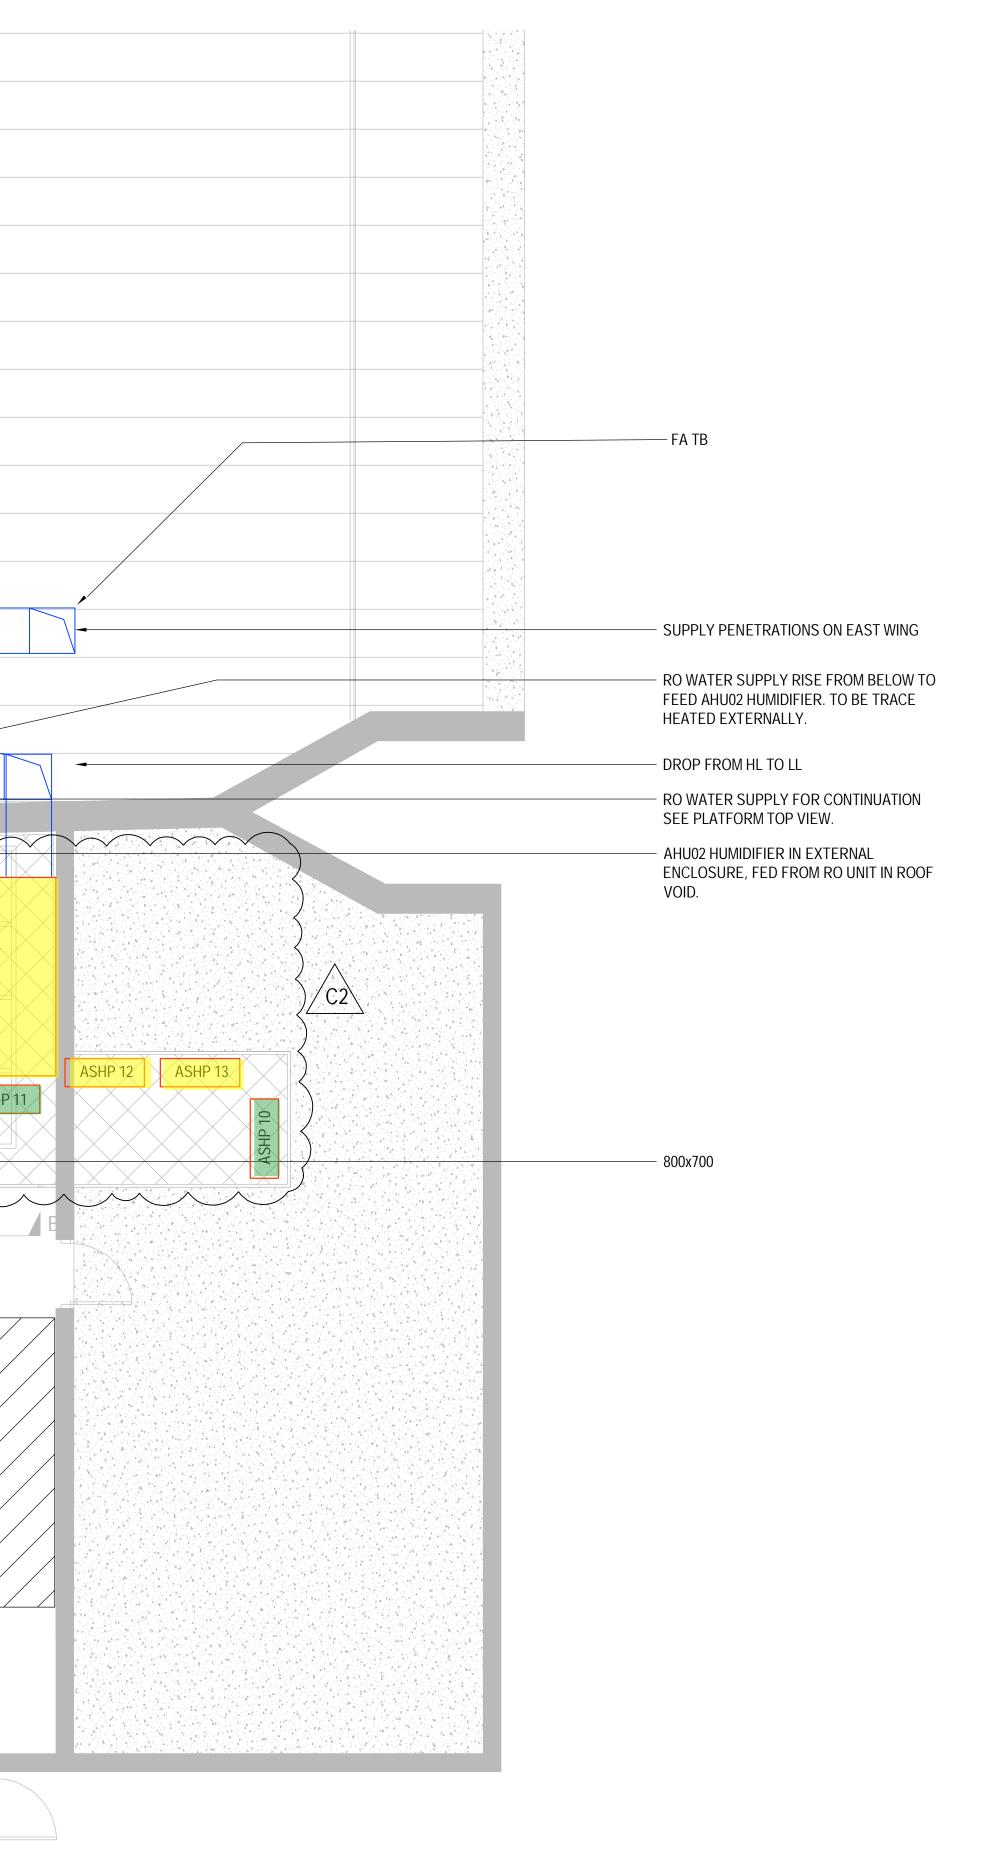




PROPOSED ROOF PLAN

LEGEND


NEW PLANT BEING PROPOSED

PROPOSED REPLACEMENT PLANT

Scale 1:50 @ A1

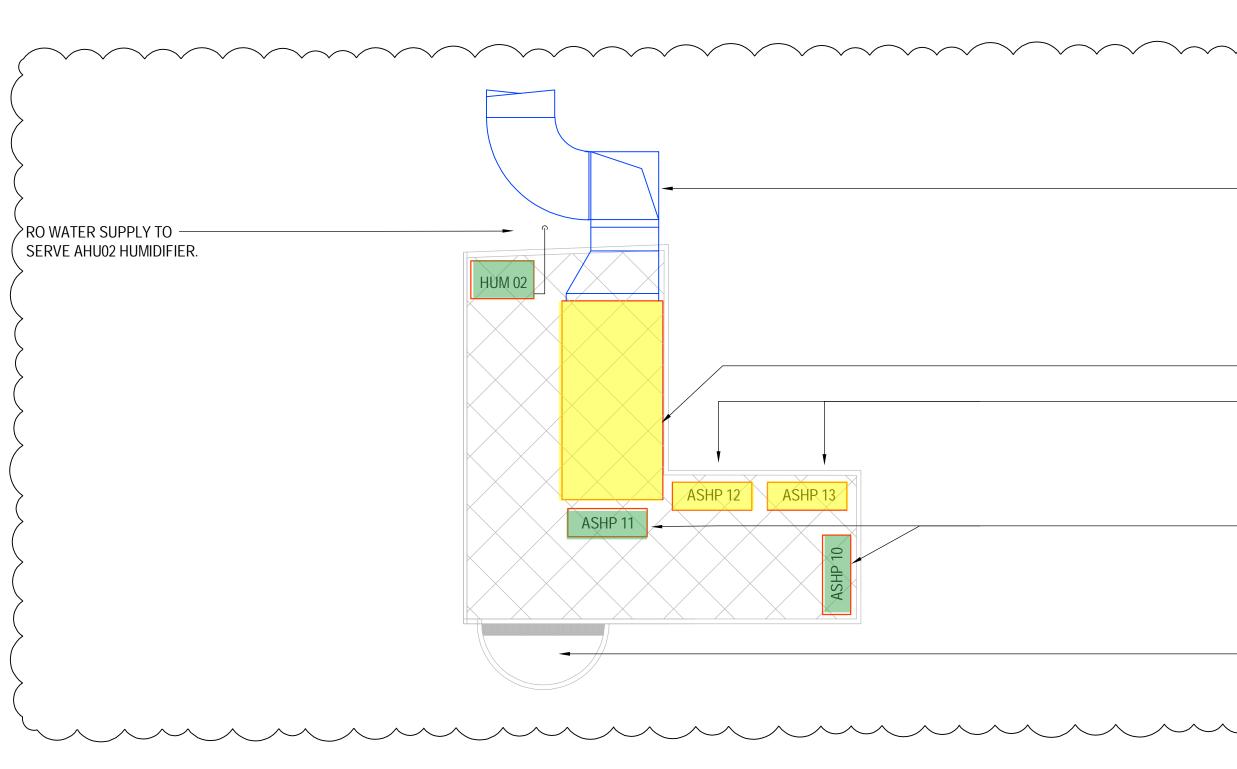

PLATFORM TOP VIEW (NTS)

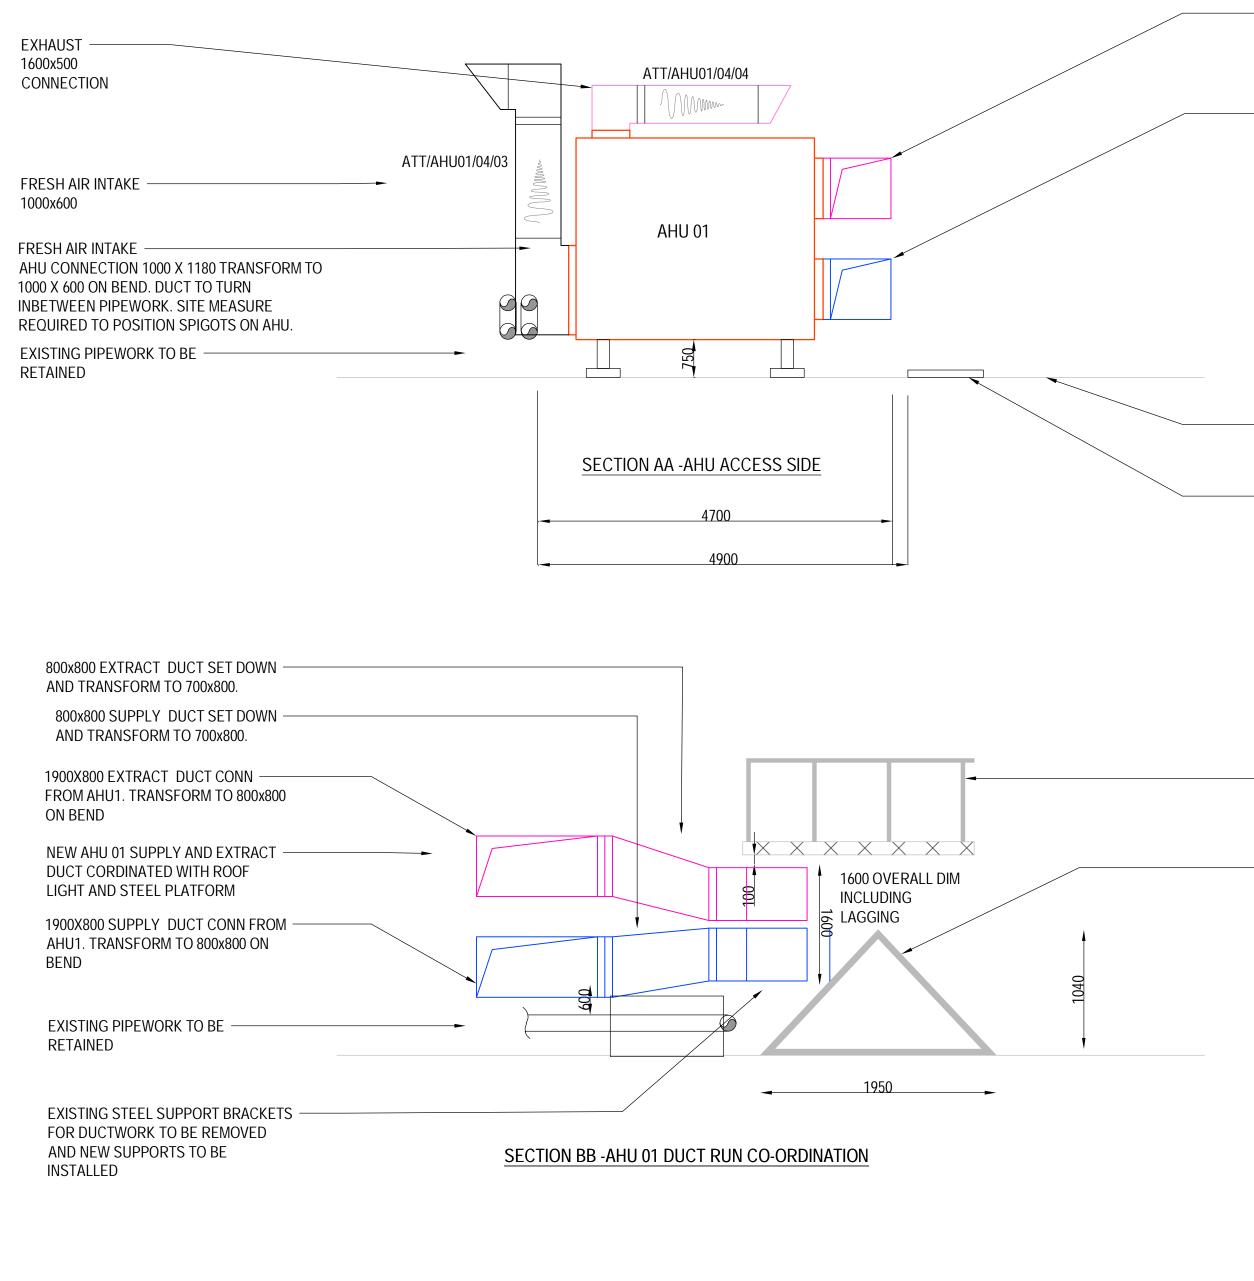

	NOTES
	 <u>NOTES</u> 1. THIS DRAWING MUST BE READ IN CONJUNCTION WITH THE M&E CONSULTANTS SPECIFICATION AND ALL OTHER RELEVANT MECHANICAL, ELECTRICAL AND PUBLIC HEALTH DRAWINGS, SCHEMATICS AND SCHEDULES. 2. ALL DIMENSIONS ARE IN MILLIMETERS (mm) UNLESS OTHERWISE STATED.
	 DO NOT SCALE FROM THIS DRAWING. ALL EXTERNAL DUCT FOR AHU -01 TO BE STRIPPED AND REPLACED. EXISTING PENETRATION TO BE UTILISED WITH MINOR MODIFICATIONS AS REQUIRED. NEW DUCT WORK FOR AHU-01 ONLY TO UTILISE EXISTING DUCT RUN ROUTE.
	 NEW DUCT MOUNTED HUMIDIFIER LANCES TO BE INSTALLED ON DROP FROM AHU 02 PLATFORM. ASHP 06-11 TO SERVE AHU 01, ASHP 12-13 SERVING AHU 02
	9. HUM 02 TO BE HOUSED IN EXTERNAL ENCLOSURE.10. NEW WATER TREATMENT PLANT TO BE INSTALLED IN INDOOR PLANTROOM UNDER AND A DECIMAL
DROP TO LL	UNDER AHU 02 PLATFORM. 11. BIRD MESH TO BE INSTALLED ON ALL INLET AND EXHAUST DUCTS. 12ALL BENDS TO BE SWEPT, NO TURNING VANES. 13. TRACE HEATING INSTALLED ON RO WATER SUPPLY TO HUMIDIFIER PIPEWORK.
AHU - 02 U SHAPE UNIT. REPLACE CONDENSER SERVING AHU 02. CONDENSE DRAINS TO BE RUN TO SAFE LOCATION TO DISCHARGE.	
2 OF 6 NEW ASHP SERVING AHU 01. CONDENSE DRAINS TO BE RUN TO SAFE LOCATION TO DISCHARGE.	
CAT LADDER	
C2	
1900X800 EXTRACT DUCT CONN TO AHU. CHANGE TO 800X800 ON BEND	
AHU SIT ON RAISED SUPPORTING PLATFORM	
ACCESS HATCH	
	C02 024 AHU02 SELECTION REVISED. JJ IH 01.02.2024 C01 - CONTRACT ISSUE JJ IH 08.12.2023 D05 - AS INDICATED IH 24.11.2023
	P05 - AS INDICATED JJ IH 24.11.2023 P04 - UPDATED TO COMMENTS JJ IH 17.11.2023 P03 - PRELIMINARY ISSUE JJ IH 13.11.2023
	P02 - PRELIMINARY ISSUE JJ ISA 27.10.2023 P01 - PRELIMINARY ISSUE JJ ISA 01.09.2023
	Rev Dcc Description Dwn Chkd Date
GLASS ROOF LIGHT	CONTRACT
	TROUP 183 Eversholt Street BYVVATERS 183 Eversholt Street London NW1 1BU t. +44 (0)20 7504 1400 e: Ih@tbanda.com w: www.tbanda.com Bringing Buildings to Life w: www.tbanda.com
	Project UCL BSU UPN 016 Medical Science & Anatomy
05	Title PROPOSED ROOF LEVEL PLANTROOM LAYOUT DARWIN BUILDING
25 M	Client DMA
	Architect N/A Project No. Drawn By Date Checked Scale
	Project No.Drawn ByDrateCheckedScaleLH0527JJ01-09-2023ISA1:50Acad ModelRevision
	LH0527_LO_LM_M_UPN016_006