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**Drawing Naming Convention:**

Job No\Code\Dwg type\Location\Ref  
 Code: 13 = Existing 14 = Proposed  
 Dwg Type: B = Building E = Elevation  
 S = Section T = Topographical  
 Location: B = Basement C = Ceiling Plan  
 E = External F = Front  
 G = Ground S = Side  
 I = First R = Rear  
 R = Roof GA = General Layout  
 M = Mezzanine AA = Section A-A  
 Ref Ref to individual dwg I.D. (e.g. Revision)

**Symbols (where applicable):**



DIRECTION OF SLOPING CEILING



FLOOR TO STRUCTURAL CEILING HT



FLOOR TO SUSPENDED CEILING HT



FLOOR LEVEL RELATIVE TO DATUM

**Notes:**

The Survey has been computed on an arbitrary grid.  
 All Levels are in metres and relate to an arbitrary site datum.  
 Front step. Value 9.16m.  
 All direction arrows indicate DOWN unless otherwise stated.  
 Drainage pipe sizes (where shown) have been gauged from the surface (for safety reasons) and should be regarded as approximate only.  
 Visible features in the vicinity of any boundaries, as shown on this survey, may not represent the extent of legally conveyed ownership.  
 Whilst every effort has been made to determine wall materials, no guarantee is given. Materials should be regarded as assumed unless verified by a qualified third party.

Rev	Date	By	Description

**CARDOE MARTIN**

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Client:  
**PARAMOUT COURT RES LTD**

Project:  
**PARAMOUNT COURT,  
 55 UNIVERSITY STREET,  
 LONDON**

Drawing Title:  
**PROPOSED  
 ELEVATION No.1**

Date: 12.09.23	Scale: 1:250@A3	Surveyor: MM	Drawn: SOT	Checked: MM
Job No: 23052	Drawing No: 23052-13-P-1	Sheet No: 1 OF 1	Rev:	


Free standing railing height raised by 150mm

Access ladder replaced with galv steel to DIN 18799-1g

Cracked/defective brickwork on roof plant rooms to be replaced to closely match original

Main Roof height (hidden) raised by 150mm due to insulation. Roof covering .....

Access ladder replaced with galv steel to DIN 18799-1g

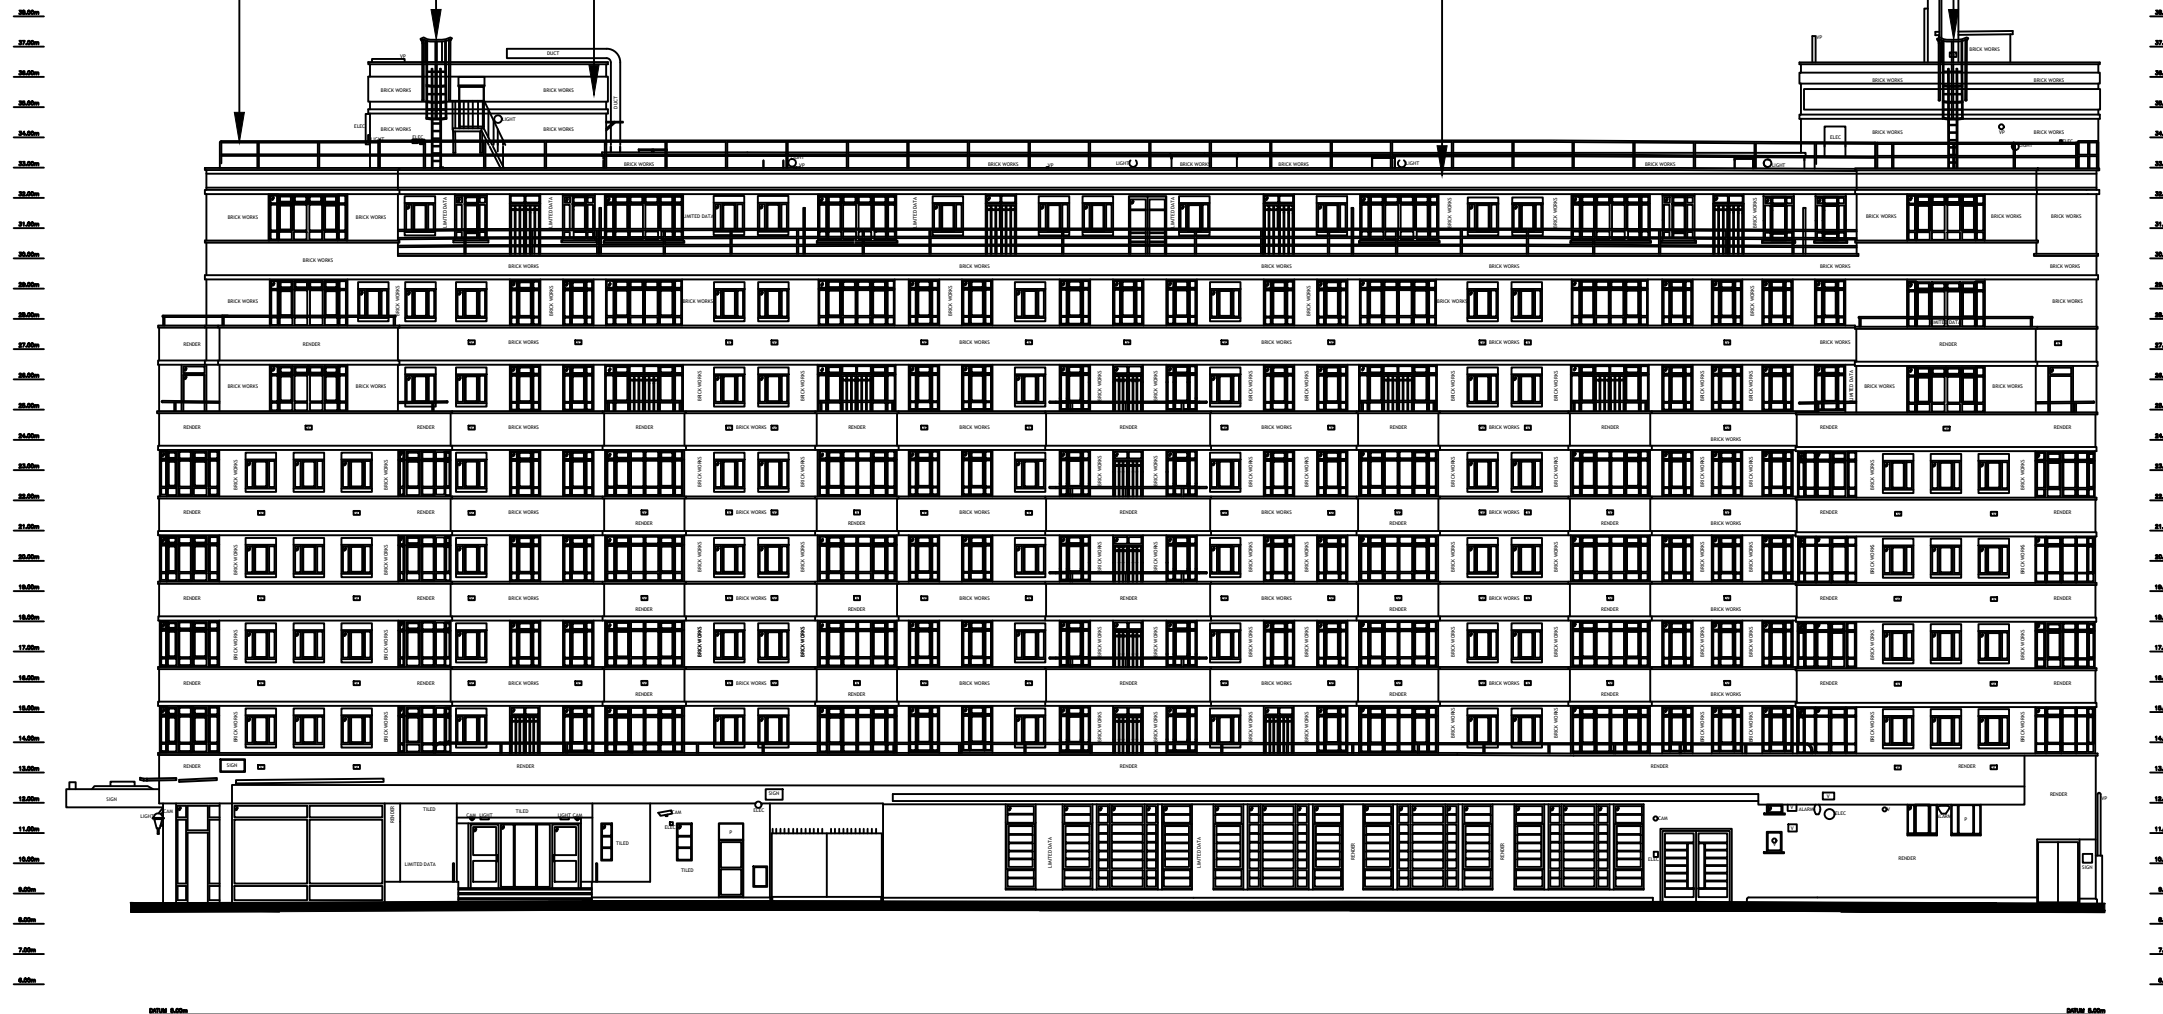

EXISTING ELEVATION No.1

