

- 1. ALL DIMENSIONS TO BE VERIFIED ON SITE.
- 2.READ IN CONJUNCTION WITH ARCHITECT'S DRAWINGS.
- $3. \mathrm{ALL}$  STEELWORK DESIGNED TO BS 5950 FABRICATED TO BS 5950.
- 5.APPLY 2 COATS OF RED OXIDE PRIMER TO ALL STEEL PRIOR TO ERECTION. 4.ALL STEEL MEMBERS TO BE GRADE S355 STEEL.
- 6.ALL STEEL BEAMS TO HAVE 1 HOUR FIRE RESISTANCE CAPABILITY MIN (e.g. 12.5 mm PLASTERBOARD AND 7mm SKIM).
- 7. ALL WELDING TO BE  $6 \mathrm{mm}$  FILLET WELDS CARRIED OUT IN WORKSHOP.
- 8.ALL BLACK BOLTS TO BE GRADE 8.8.
- 9.ALL TIMBERWORK DESIGNED TO BS 5268.
- 0. DOUBLE JOISTS TO BE BOLTED TOGETHER WITH M-12 BOLTS + 63mm dia. TP CONNECTORS AND WASHER PLATE @ 450 c/c.
- 11. CONNECTIONS:
  TIMBER/BRICK: BAT SPH HANGER WHEN
  THERE IS A MINIMUM OF
  675mm OF BRICKWORK
  ABOVE, IF NOT USE MAXI
  SPEEDY HANGERS.
  TIMBER'TIMBER: BAT JIFFY HANGER OR
  FRAMING ANCHOR.
  ALLOW FOR BAT M305 STRAPS @ 1200 v/c FOR
  RESTRAINT.
- CONCRETE PADSTONES TO BE GRADE 25 (1:2:4).
- 13. ALL TEMPORARY PROPPING BY THE CONTRACTOR.
- 14. ALL WATERPROOFING AND DRAINAGE TO ARCHITECT'S SPECIFICATION.
- 15. ALL WORKS TO BE APPROVED BY THE BUILDING CONTROL OFFICER.
- 16. NO WORK TO COMMENCE ON SITE PRIOR TO BUILDING CONTROL APPROVAL OF STRUCTURAL DETAILS.
- 17. ANY BEAMS, JOISTS HANGERS, OR OTHER STRUCTURAL WORKS ATTACHED TO PARTY WALL MAY BE SUBJECT TO PARTY WALL AGREEMENT.

### FOR PLANNING APPLICATION PRELIMINARY SCHEME

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	20.09.23 REVISED DRAWING	
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(Showing FIRST FLOOR STRUCTURE above)

Scale 1:50 @ A1 & 1:100 @ A3

### ≓e Showing FLOOR Structure above GROUND FLOOR PLAN


Consulting Civil & Structural Engineers Martin Redston Associates


4 Edward Square, London N1 OSP

Tel: 020-7837 5377

Job No. 23.206	Eng. sc	Date August July 2023
	Scale 1.50 @ A1 1.100 @ A3	2023
	03	Sheet No.
	1	Rev

Project 118 Malden Road London NW5 4BY

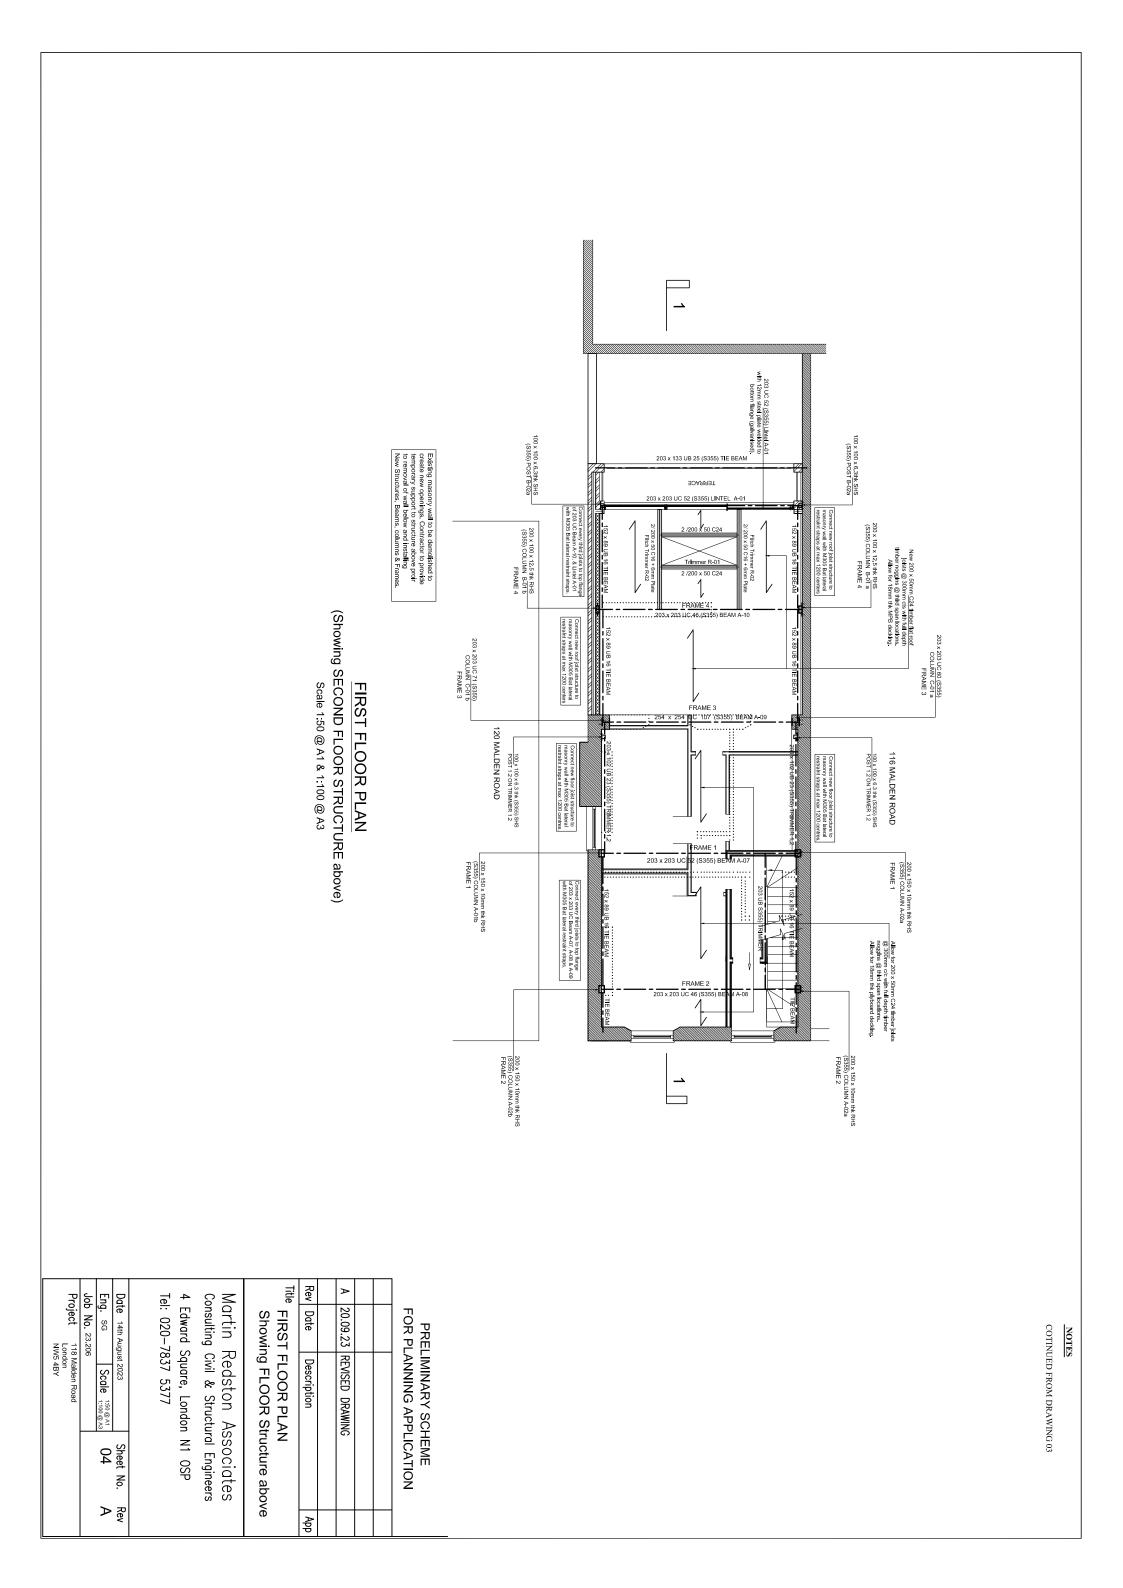

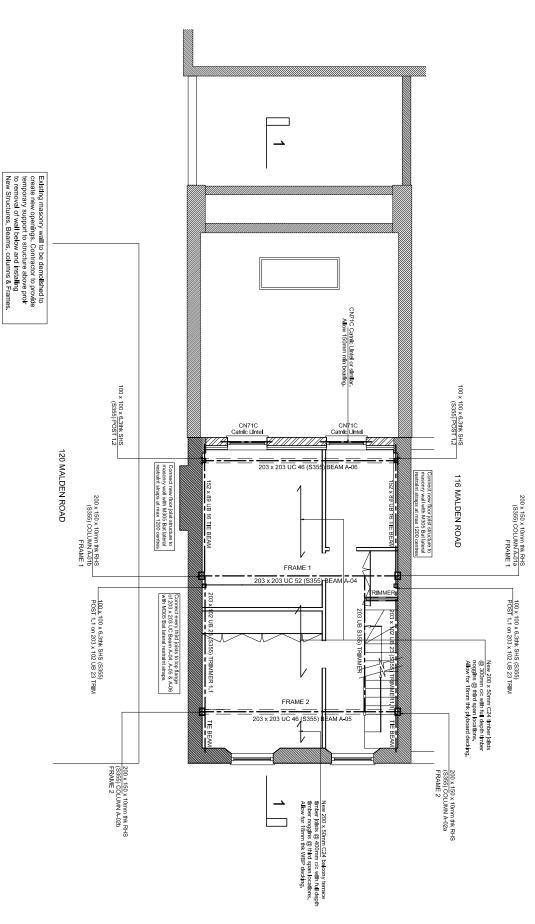

# SECOND FLOOR PLAN

(Showing LOFT FLOOR STRUCTURE above)

Scale 1:50 @ A1 & 1:100 @ A3

- 1. ALL DIMENSIONS TO BE VERIFIED ON SITE.
- 2.READ IN CONJUNCTION WITH ARCHITECT'S DRAWINGS.
- 3.ALL STEELWORK DESIGNED TO BS 5950 FABRICATED TO BS 5950.
- $5.\mathsf{APPLY}\ 2$  COATS OF RED OXIDE PRIMER TO ALL STEEL PRIOR TO ERECTION. 4.ALL STEEL MEMBERS TO BE GRADE S355 STEEL
- 6.ALL STEEL BEAMS TO HAVE 1 HOUR FIRE RESISTANCE CAPABILITY MIN (e.g. 12.5 mm PLASTERBOARD AND 7mm SKIM).
- 7.ALL WELDING TO BE  $6\mathrm{mm}$  FILLET WELDS CARRIED OUT IN WORKSHOP.
- 8.ALL BLACK BOLTS TO BE GRADE 8.8.
- 9.ALL TIMBERWORK DESIGNED TO BS 5268.
- 10. DOUBLE JOISTS TO BE BOLTED TOGETHER WITH M-12 BOLTS + 63mm dia. TP CONNECTORS AND WASHER PLATE @ 450 c/c.
- II. CONNECTIONS:
  TIMBER/BRICK: BAT SPH HANGER WHEN
  THERE IS A MINIMUM OF
  675mm OF BRICKWORK
  ABOVE, IF NOT USE MAXI
  SPEEDY HANGERS.
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  FRAMING ANCHOR.
  ALLOW FOR BAT M305 STRAPS @ 1200 c/c FOR
  RESTRAINT.
- 12. CONCRETE PADSTONES TO BE GRADE 25 (1:2:4).
- 13. ALL TEMPORARY PROPPING BY THE CONTRACTOR.
- 14. ALL WATERPROOFING AND DRAINAGE TO ARCHITECT'S SPECIFICATION.

15. ALL WORKS TO BE APPROVED BY THE BUILDING CONTROL OFFICER.

- 16. NO WORK TO COMMENCE ON SITE PRIOR TO BUILDING CONTROL APPROVAL OF STRUCTURAL DETAILS.
- 17. ANY BEAMS, JOISTS HANGERS, OR OTHER STRUCTURAL WORKS ATTACHED TO PARTY WALL MAY BE SUBJECT TO PARTY WALL AGREEMENT.

### FOR PLANNING APPLICATION PRELIMINARY SCHEME


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ı	20.09.23 REVISED DRAWING	20.09.23	Α

# SECOND FLOOR PLAN Showing LOFT FLOOR Structure

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Date         14th August 2023         Sheet No.         Rev           Eng. SG         Scale         1:50 @ A1         05         A           Job No. 23.206         A         A         A         A			118 Malden Road	Project 1181
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	Rev	Sheet No.	t 2023	Date 14th Augus



- 1. ALL DIMENSIONS TO BE VERIFIED ON SITE.
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- 7.ALL WELDING TO BE 6mm FILLET WELDS CARRIED OUT IN WORKSHOP.
- 8. ALL BLACK BOLTS TO BE GRADE 8.8.
- 9.ALL TIMBERWORK DESIGNED TO BS 5268.
- 10. DOUBLE JOISTS TO BE BOLTED TOGETHER WITH M-12 BOLTS + 63mm dia. TP CONNECTORS AND WASHER PLATE @ 450 c/c.
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### FOR PLANNING APPLICATION PRELIMINARY SCHEME
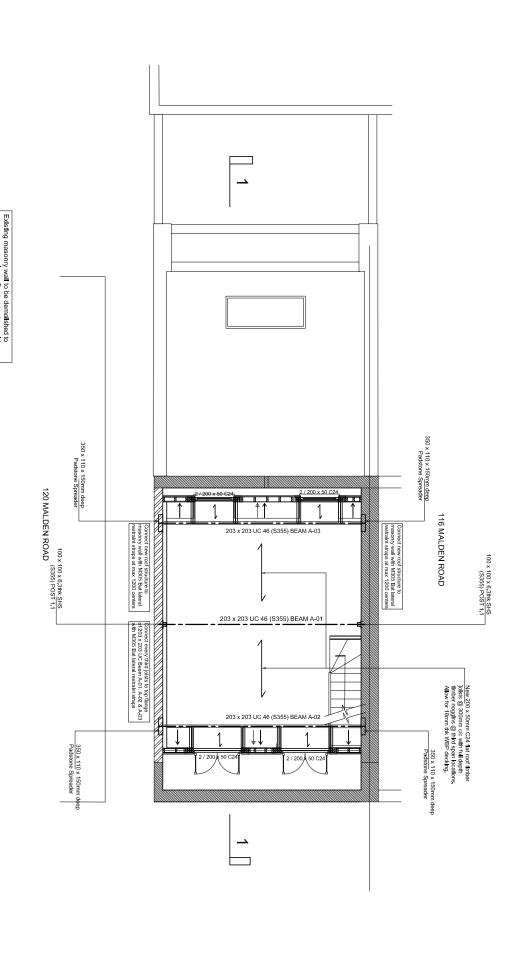
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(Showing ROOF STRUCTURE Structure)

LOFT FLOOR PLAN


Scale 1:50 @ A1 & 1:100 @ A3

## LOFT FLOOR PLAN Showing ROOF Structure above

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Date 14th August 2023	August	2023	Sheet No.	Rev
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Job No. 23.206				
Project	118 M	118 Malden Road		
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# **SECTION 1-1**

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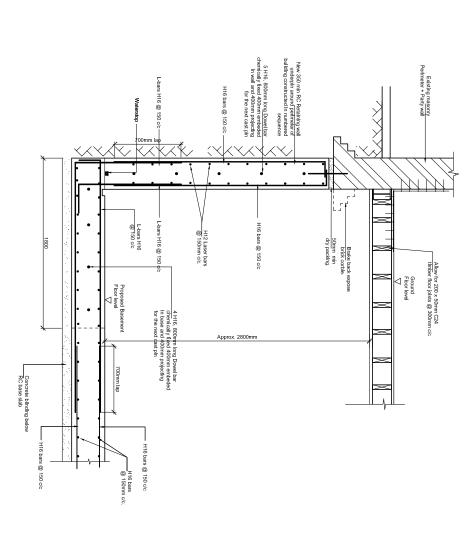
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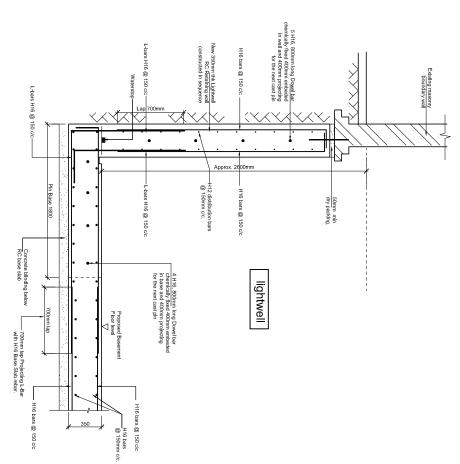
# SECTION 1-1

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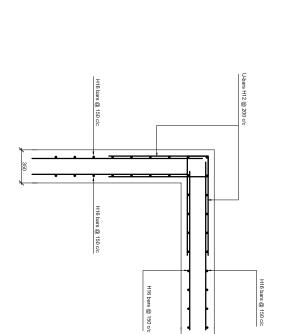
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Typical Masonry Perimeter + Partywall Underpinning Detail A-A Scale 1.20

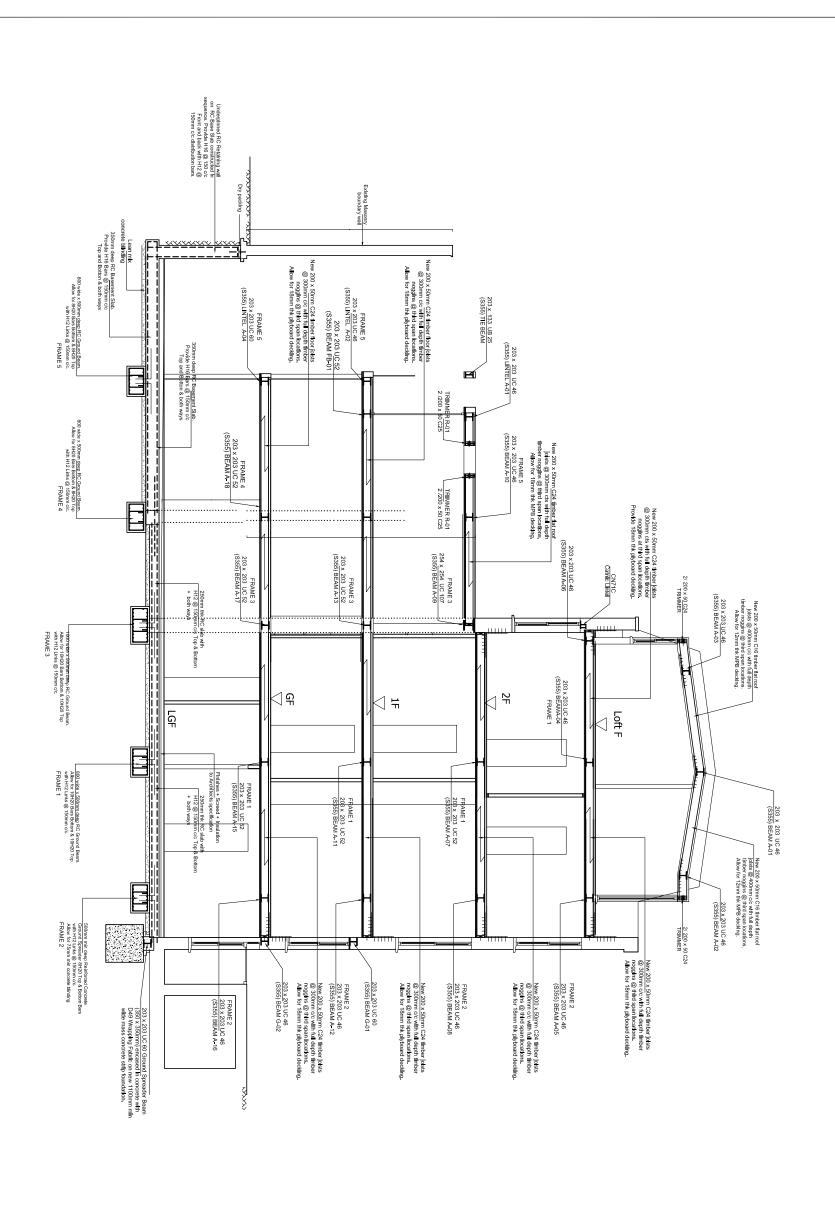

Typical Lightwell Retaining Wall Detail B-B Scale 1:20



R.C WALL CORNER BAR DETAIL

Scale 1:20

# EXCAVATION FOR REINFORCED CONCRETE RETAINING WALLS

- I. WORKING IN STRIPS NOT EXCEEDING IM LONG EXCAVATE TO REQUIRED DEPTH ADJACENT EXISTING STRUCTURE.
- 2.CAST NEW CONCRETE BASE AND ALLOW 24 HOURS TO CURE. STARTER BARS TO EXTEND 40d ABOVE BASE FOR LAPPING PURPOSES (SEE DETAILS FOR BAR SIZES).
- S. VERTICAL & HORIZONTAL REINFORCEMENT TO BE CONSTRUCTED IN ACCORDANCE WITH DESIGN INFORMATION AND ANY REINFORCEMENT SCHEDULES PROVIDED BY THE ENGINEER.
- 4.SHUTTERING & PROPPING TO BE DESIGNED BY CONTRACTOR.
- S.CAST NEW CONCRETE WALL ENSURING GROUND BEHIND NEW FOUNDATION & WALL IS FULLY BACKFILLED AND COMPACTED. CHECK AT REGULAR INTERVALS TO ENSURE THIS DURING CONSTRUCTION.
- $6.\mbox{NEVER}$  EXCAVATE TWO ADJACENT STRIPS WITHOUT ALLOWING 3 DAYS BETWEEN OPERATIONS.
- 7.WHEN ADJACENT SECTIONS ARE OPENED UP THE EXPOSED CONCRETE SURFACES SHOULD BE THOROUGHLY CLEANED OF ALL LOOSE MATERIAL & SCABBLED TO FORM A GOOD KEY.
- 8. ALL REASONABLE CARE IS TO BE TAKEN TO PREVENT INJURIES TO PERSONS WORKING NEAR EXPOSED BARS ETC. (THREADED COUPLERS WOULD BE SUITABLE).
- $9.\mbox{ALL}$  NEW CONCRETE BELOW GROUND TO BE SULPHATE RESISTING CEMENT CONC. GRADE 35.
- 10. TRIAL PIT TO BE EXCAVATED TO CONFIRM EXISTANCE OF ANY EXISTING STRUCTURE. 1. REINFORCEMENT SHALL BE TO BS-8110 WITH MAIN BARS TO BE GRADE 460 (HIGH YIELD).
- 12. READY MIX CONCRETE MUST BE OBTAINED FROM A PLANT THAT HOLDS A CURRENT CERTIFICATE OF ACCREDITATION UNDER THE QUALITY SCHEME FOR READY MIX CONCRETE.
- 13. NO CONCRETE IS TO BE PLACED WHEN THE AMBIENT AIR TEMPERATURE IS LESS THAN 5 DEGREES C.

I. WORKING IN STRIPS NOT EXCEEDING IM LONG EXCAVATE REQUIRED DEPTH BENEATH EXISTING FOOTING.

SEQUENCE OF UNDERPINNING

- 2.HACK AWAY TO PROVIDE LEVEL SOFFIT TO EXISTING BRIFOOTING AND THOROUGHLY CLEAN BEFORE UNDERPINNING.
- 3.CAST NEW CONCRETE TO WITHIN 75mm OF SOFFIT OF EXISTI FOOTING AND ALLOW 24 HOURS TO CURE.
- . RAM IN DRY PACK MORTAR BETWEEN NEW AND EXISTING FOOTINGS.
- $5.{\rm NEVER}$  EXCAVATE TWO ADJACENT STRIPS WITHOUT ALLOWING 3 DAYS FROM TIME OF DRY PACKING.
- 6.WHEN ADJACENT SECTIONS ARE OPENED UP THE EXPOSED CONCRETE SURFACES SHOULD BE THOROUGHLY CLEANED OF ALL LOOSE MATERIAL AND SCRABBLED TO FORM A GOOD KEY. 7. UNDERPINNING TO BE 1000mm WIDE UNLESS NOTED OTHERWISE.
- 8. ALL NEW CONCRETE BELOW GROUND TO BE SULPHATE RESISTING CEMENT CONC. GRADE 35.
- 10. WHEN LOWERING FLOORS IN BASEMENTS, ALL WALLS MUST BE UNDERPINNED BEFORE DIGGING OUT FLOOR . 9.DRY PACK - 3:1 SAND CEMENT.
- II. CONTRACTOR TO CAREFULLY INSPECT ALL EXISTING MASONRY PRIOR TO UNDERPINNING EACH BAY IN SEQUENCE. REPORT ANY ANOMALIES TO ENGINEER FOR ADVICE AND REASSESSMENT OF SCHEME.
- 2. UNDERPINNING SECTIONS TO BE CAST IN NUMERICAL ORDER SEE FOUNDATION PLAN FOR DETAILS.
- SPECIFICATION. ALL DATACTORS SPECIFICATION ALL OTHER WATERPROOFING AND DRAINAGE TO ARCHITECTS SPECIFICATION.

### FOR PLANNING APPLICATION PRELIMINARY SCHEME

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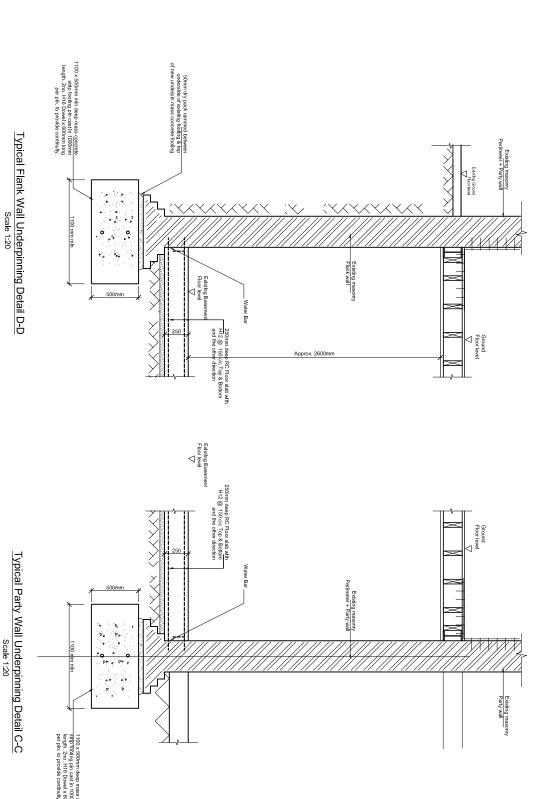
# Title Existing masonry wall Underpin Retaining wall Detail A-A & Detail B-B

Consulting Civil & Structural Engineers Martin Redston Associates

4 Edward Square, London N1 OSP Tel: 020-7837 5377

<b>Date</b> 10th Nov 2023	23	Sheet No.	Rev
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Job No. 23.206			
<b>Project</b> 116 N	116 Malden Road		

London NW5 4BY



TIMBER/BRICK: BAT SPH HANGER WHEN
THERE IS A MINIMUM OF
675mm OF BRICKWORK
ABOVE, IF NOT USE MAXI
SPEEDY HANGER OR
TIMBER/TIMBER: BAT JIFFY HANGER OR
ALLOW FOR BAT M305 STRAPS @ 1200 c/c FOR
RESTRAINT.

12. CONCRETE PADSTONES TO BE GRADE 25 (1:2:4).

3. ALL TEMPORARY PROPPING BY THE CONTRACTOR.

10. DOUBLE JOISTS TO BE BOLTED TOGETHER WITH M-12 BOLTS + 63mm dia. TP CONNECTORS AND WASHER PLATE @ 450 c/c.

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7.ALL WELDING TO BE 6mm FILLET WELDS CARRIED OUT IN WORKSHOP.

 $3. \mathrm{ALL}$  STEELWORK DESIGNED TO BS 5950 FABRICATED TO BS 5950.

2.READ IN CONJUNCTION WITH ARCHITECT'S DRAWINGS.

1. ALL DIMENSIONS TO BE VERIFIED ON SITE.

## SEQUENCE OF UNDERPINNING

2.HACK AWAY TO PROVIDE LEVEL SOFFIT TO EXISTING BRICK FOOTING AND THOROUGHLY CLEAN BEFORE UNDERPINNING. I. WORKING IN STRIPS NOT EXCEEDING IM LONG EXCAVATE TO REQUIRED DEPTH BENEATH EXISTING FOOTING. .CAST NEW CONCRETE TO WITHIN 75mm OF SOFFIT OF EXISTING FOOTING AND ALLOW 24 HOURS TO CURE.

. RAM IN DRY PACK MORTAR BETWEEN NEW AND EXISTING FOOTINGS.

Typical Party Wall Underpinning Detail C-C Scale 1:20

:NEVER EXCAVATE TWO ADJACENT STRIPS WITHOUT ALLOWING 3 DAYS FROM TIME OF DRY PACKING. WHEN ADJACENT SECTIONS ARE OPENED UP THE EXPOSED CONCRETE SURFACES SHOULD BE THOROUGHLY CLEANED OF ALL LOOSE MATERIAL AND SCRABBLED TO FORM A GOOD KEY.

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II. CONTRACTOR TO CAREFULLY INSPECT ALL EXISTING MASONRY PRIOR TO UNDERPINNING EACH BAY IN SEQUENCE. REPORT ANY AROMALIES TO ENGINEER FOR ADVICE AND REASSESSMENT OF UNDERPINNING SECTIONS TO BE CAST IN NUMERICAL ORDER. SEE FOUNDATION PLAN FOR DETAILS.

> FOR PLANNING APPLICATION PRELIMINARY SCHEME

16. NO WORK TO COMMENCE ON SITE PRIOR TO BUILDING CONTROL APPROVAL OF STRUCTURAL DETAILS.

7. ANY BEAMS, JOISTS HANGERS, OR OTHER STRUCTURAL WORKS ATTACHED TO PARTY WALL MAY BE SUBJECT TO PARTY WALL AGREEMENT.

5. ALL WORKS TO BE APPROVED BY THE BUILDING CONTROL OFFICER.

4. ALL WATERPROOFING AND DRAINAGE TO ARCHITECT'S SPECIFICATION.

T#6	Rev Date Description		
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i<del>d</del>e Existing masonry wall Underpin Detail C-C & Detail D-D

Consulting Civil & Structural Engineers Martin Redston Associates

4 Edward Square, London N1 OSP Tel: 020-7837 5377

Eng. sc Job No. 23.206 **Date** 10th Nov 2023 Scale 1:20 @ A: Sheet No. 09 Rev

Project 116 Malden Road London NW5 4BY

8. TANKING REQUIRED, TO CONTRACTORS SPECIFICATION, ALL OTHER WATERPROOFING AND DRAINAGE TO ARCHITECTS SPECIFICATION.