

Appendix 2 Proposed drawing set

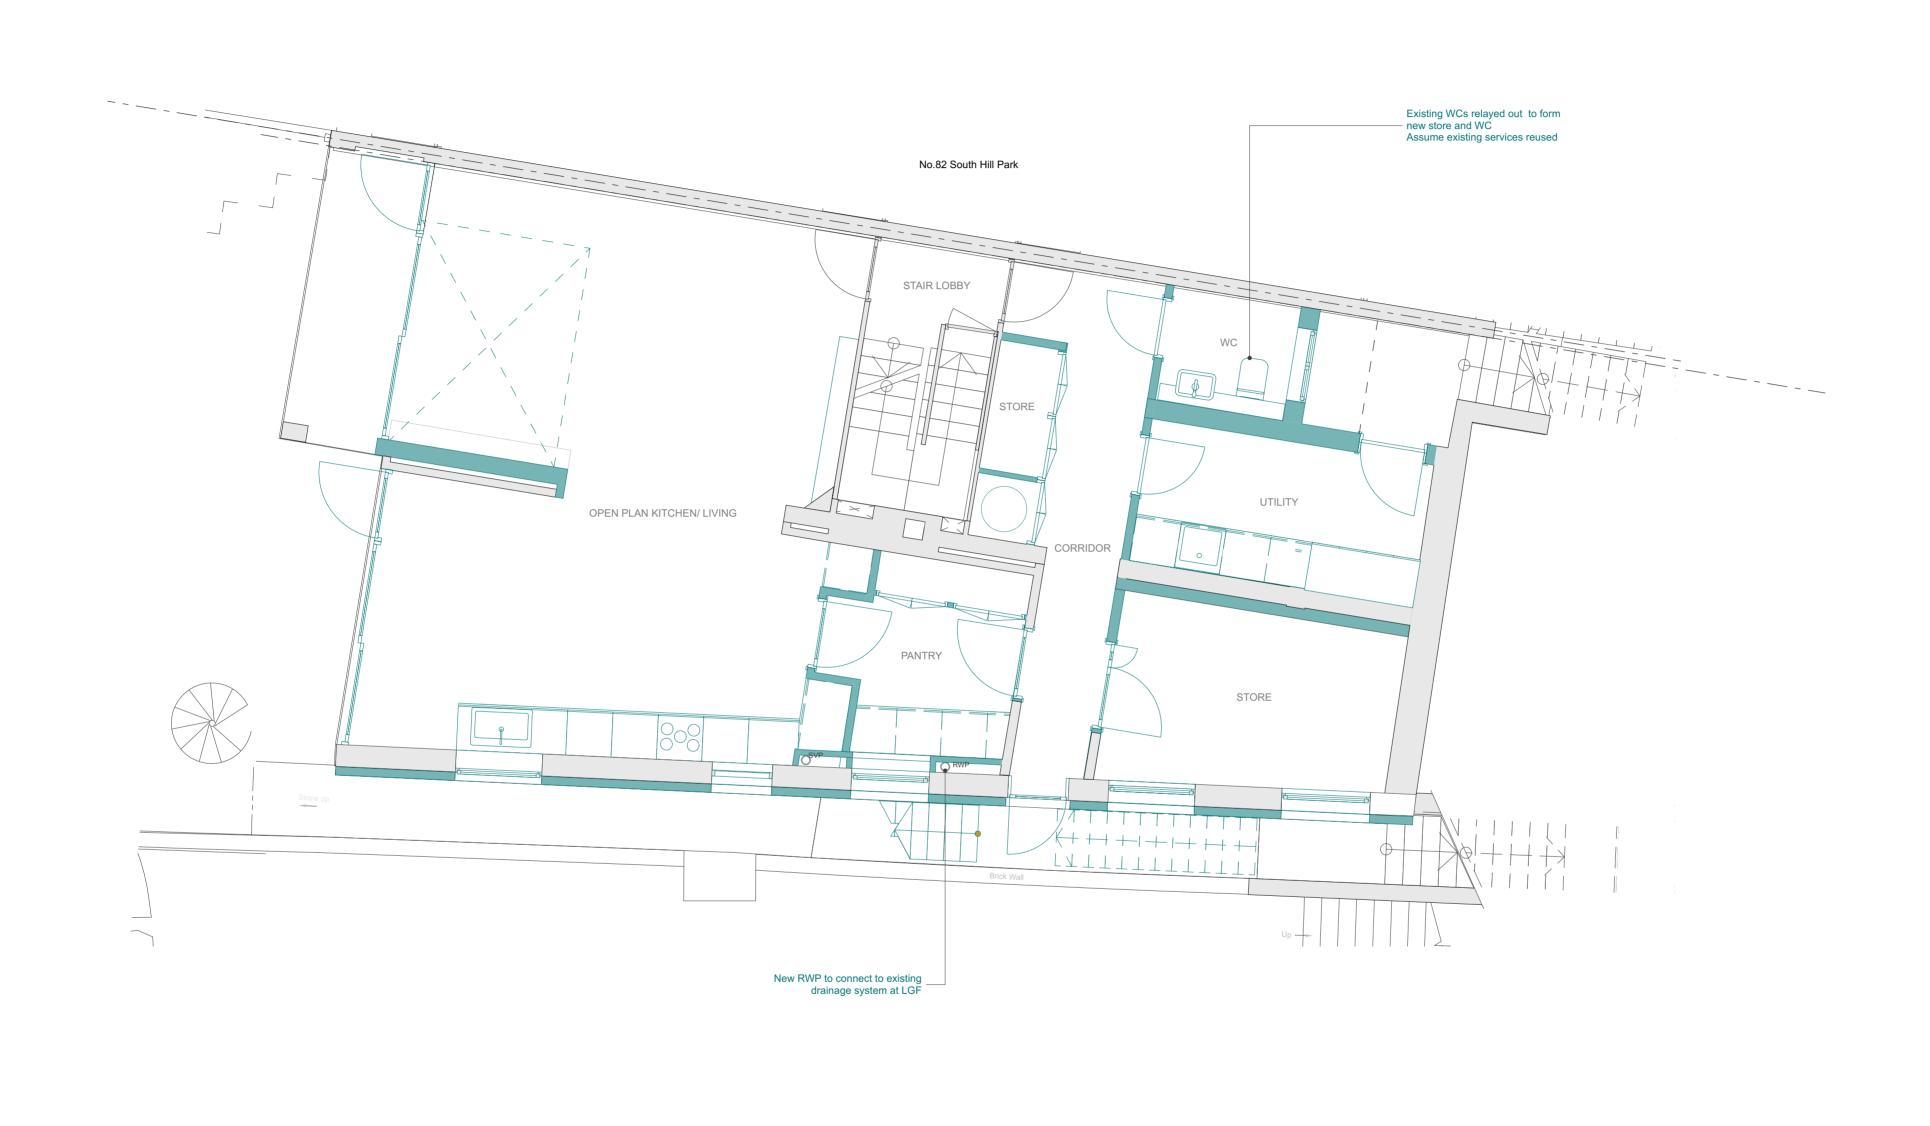


099 EXISTING LOWER GROUND FLOOR NO. 80 SOUTH HILL PARK

Existing
Proposed

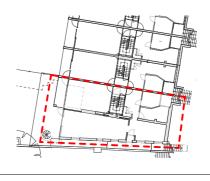


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N	
0 0.5 1 2m	

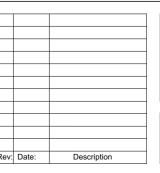

Project: 2203 No80 South Hill Park
Client: South Hill Park
Drawing: Proposed Lower Ground
Floor Plan
Drawing no: 2203-3-099
Rev: Status: Stage 3
Scale: 1:50@A2 Date: 22/12/2023

Citizensdesignbureau
Ground Floor Units 1 & 3
Ground Floor


1 : 0203 095 9732
w : www.citizensdesignbureau.net

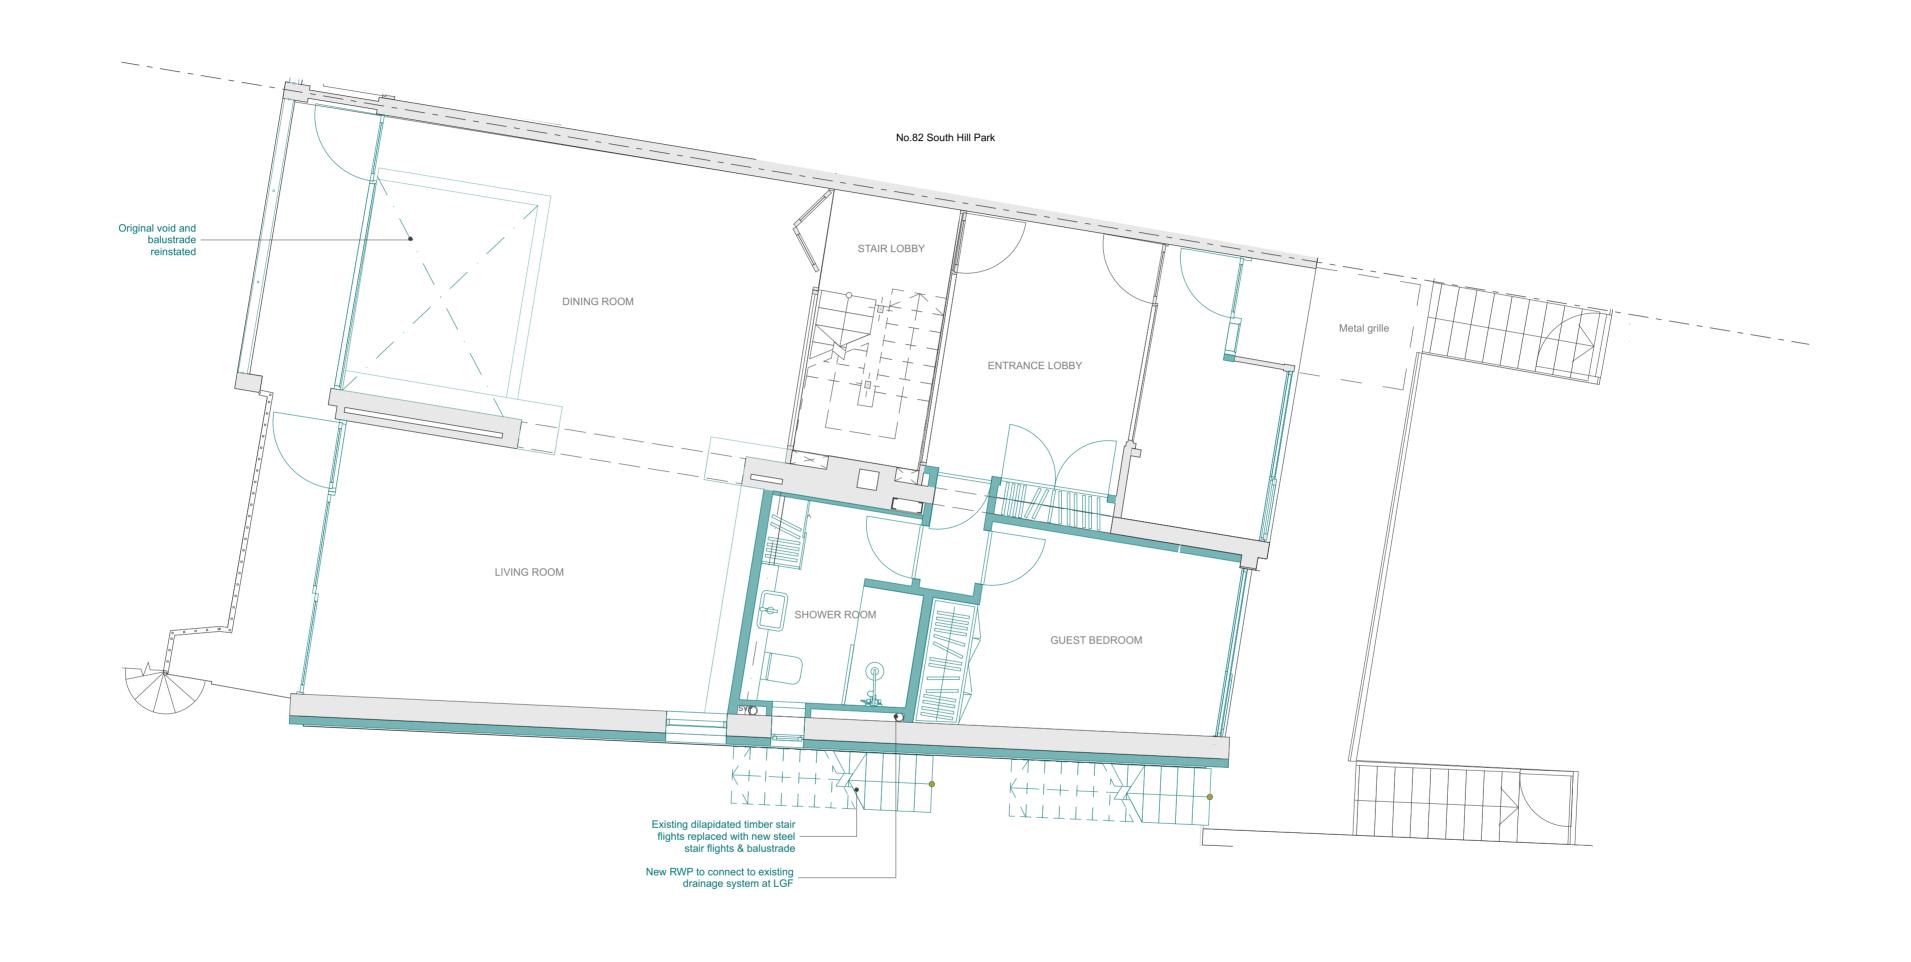

100 PROPOSED GROUND FLOOR NO. 80 SOUTH HILL PARK

Existing
Proposed



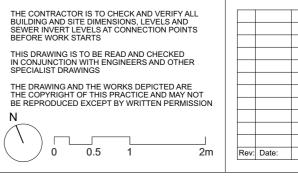


Project: 2203 No80 South Hill Park
Client: South Hill Park
Drawing: Proposed Ground Floor Plan

Drawing no: 2203-3-100


Rev: Status: Stage 3
Scale: 1:50@A2 Date: 22/12/2023

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101 PROPOSED FIRST FLOOR NO. 80 SOUTH HILL PARK

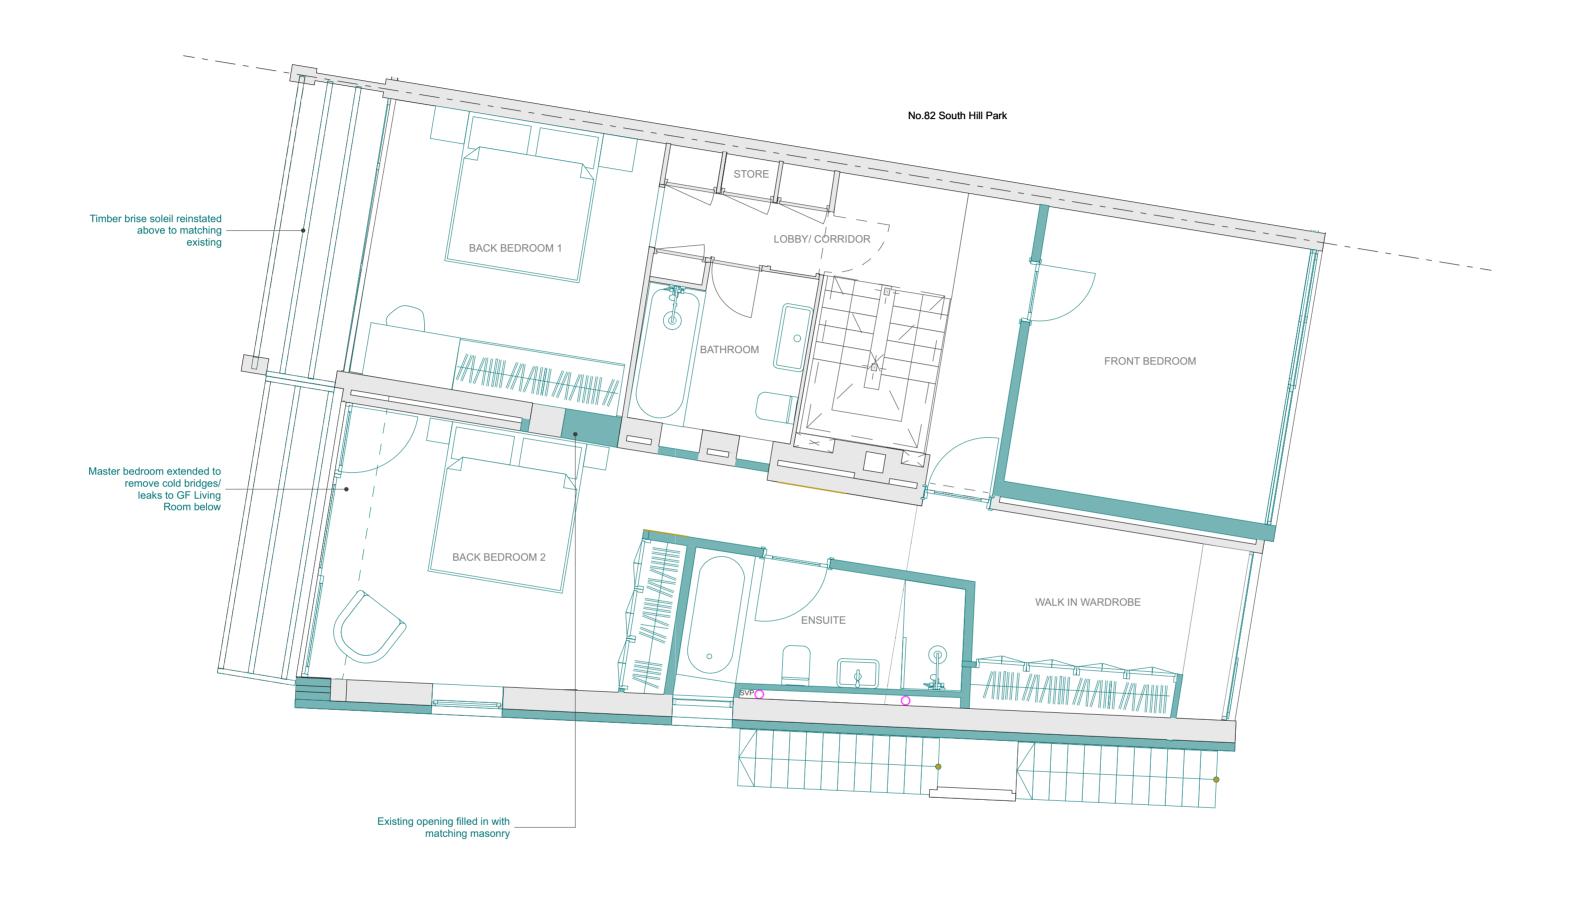Key Existing Proposed



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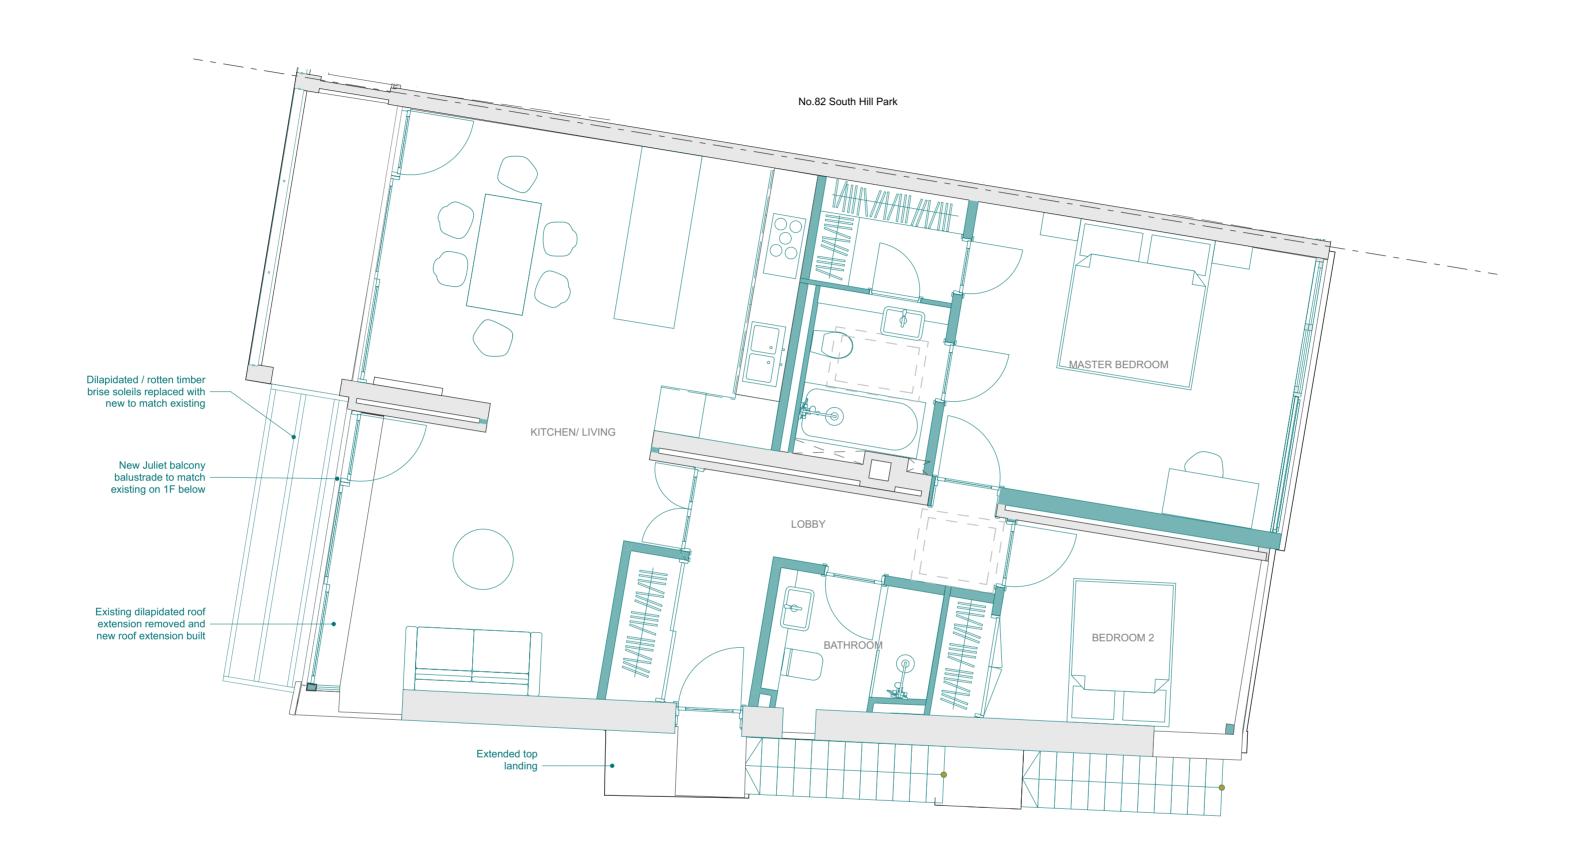
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Project: 2203 No80 South Hill Park Client: South Hill Park Rev: Date:

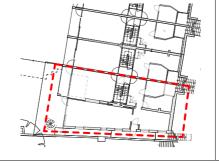
Drawing: Proposed First Floor Plan Drawing no: 2203-3-101 Status: Stage 3 Scale: 1:50@A2 Date: 22/12/2023

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102 PROPOSED SECOND FLOOR NO. 80 SOUTH HILL PARK


Existing
Proposed



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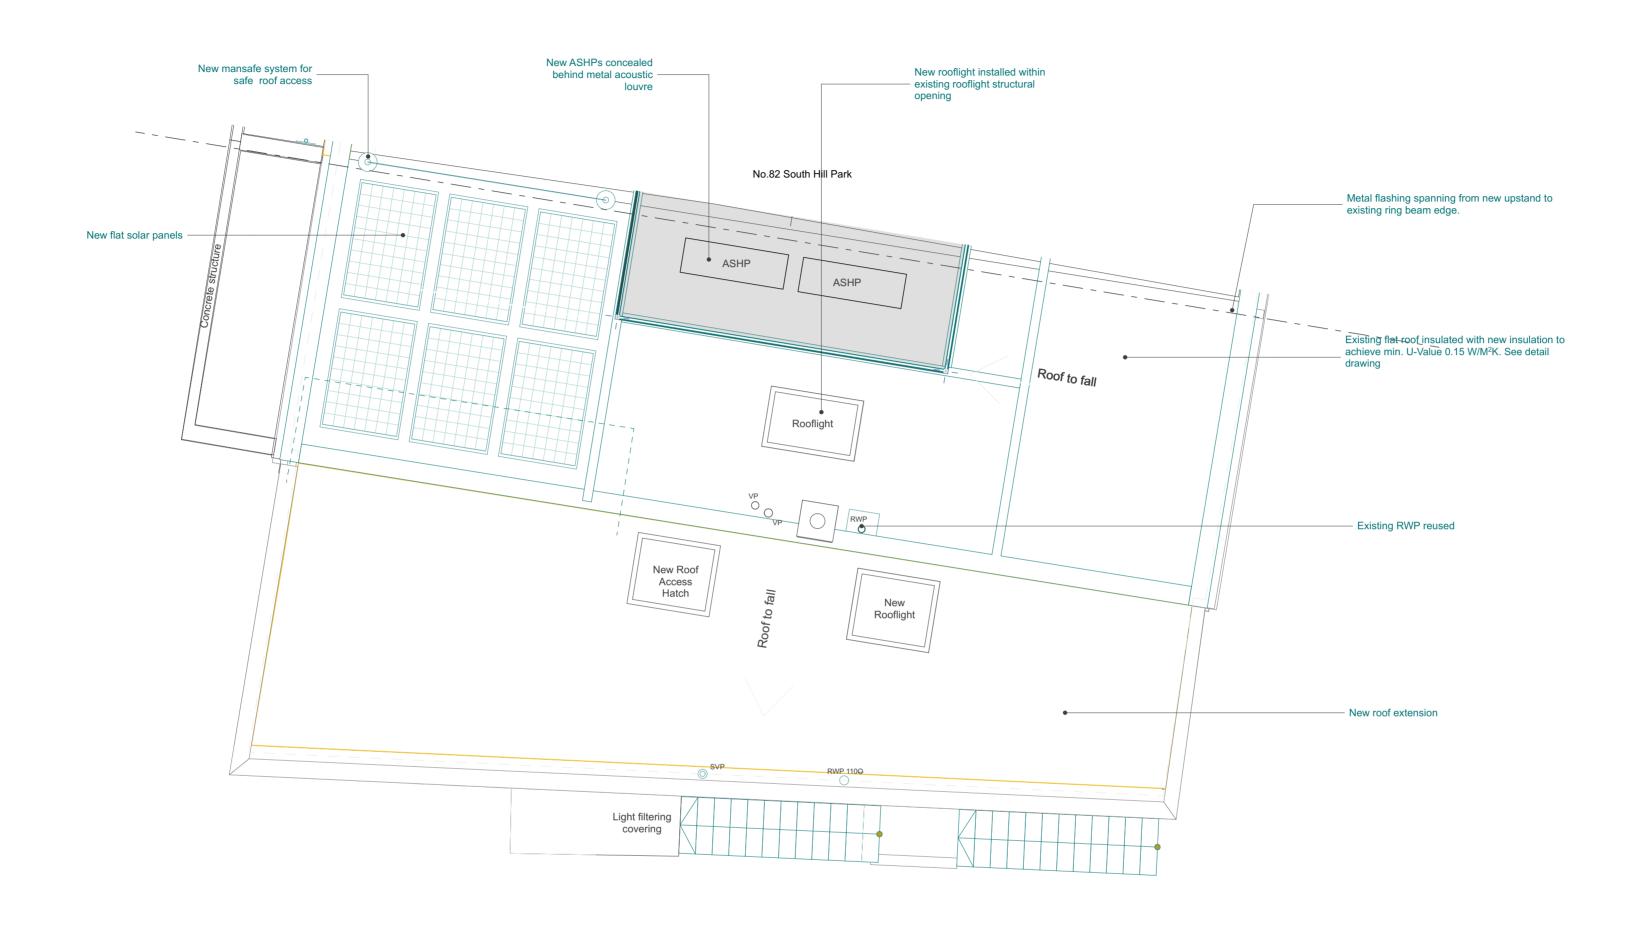


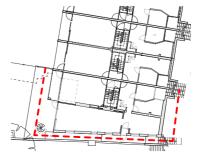Project: 2203 No80 South Hill Park
Client: South Hill Park
Drawing: Proposed Second Floor Plan

Drawing no: 2203-3-102
Rev: Status: Stage 3

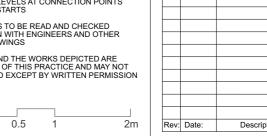
Citizens design bureau
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6 Westgate Street, London, E8 3RN
t: 0203 095 9732
w: www.citizensdesignbureau.net

Scale: 1:50@A2 Date: 22/12/2023



103 PROPOSED ROOF PLAN NO. 80 SOUTH HILL PARK


Key Existing Proposed

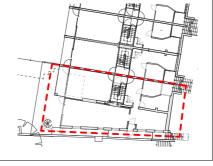

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Project: 2203 No80 South Hill Park Client: South Hill Park Drawing: Proposed Roof Plan Drawing no: 2203-3-103 Scale: 1:50@A2 Date: 22/12/2023 citizens design bureau
Ground Floor Units 1 & 3
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Status: Stage 3



106 PROPOSED ROOF PLAN IN CONTEXT NO. 80 SOUTH HILL PARK

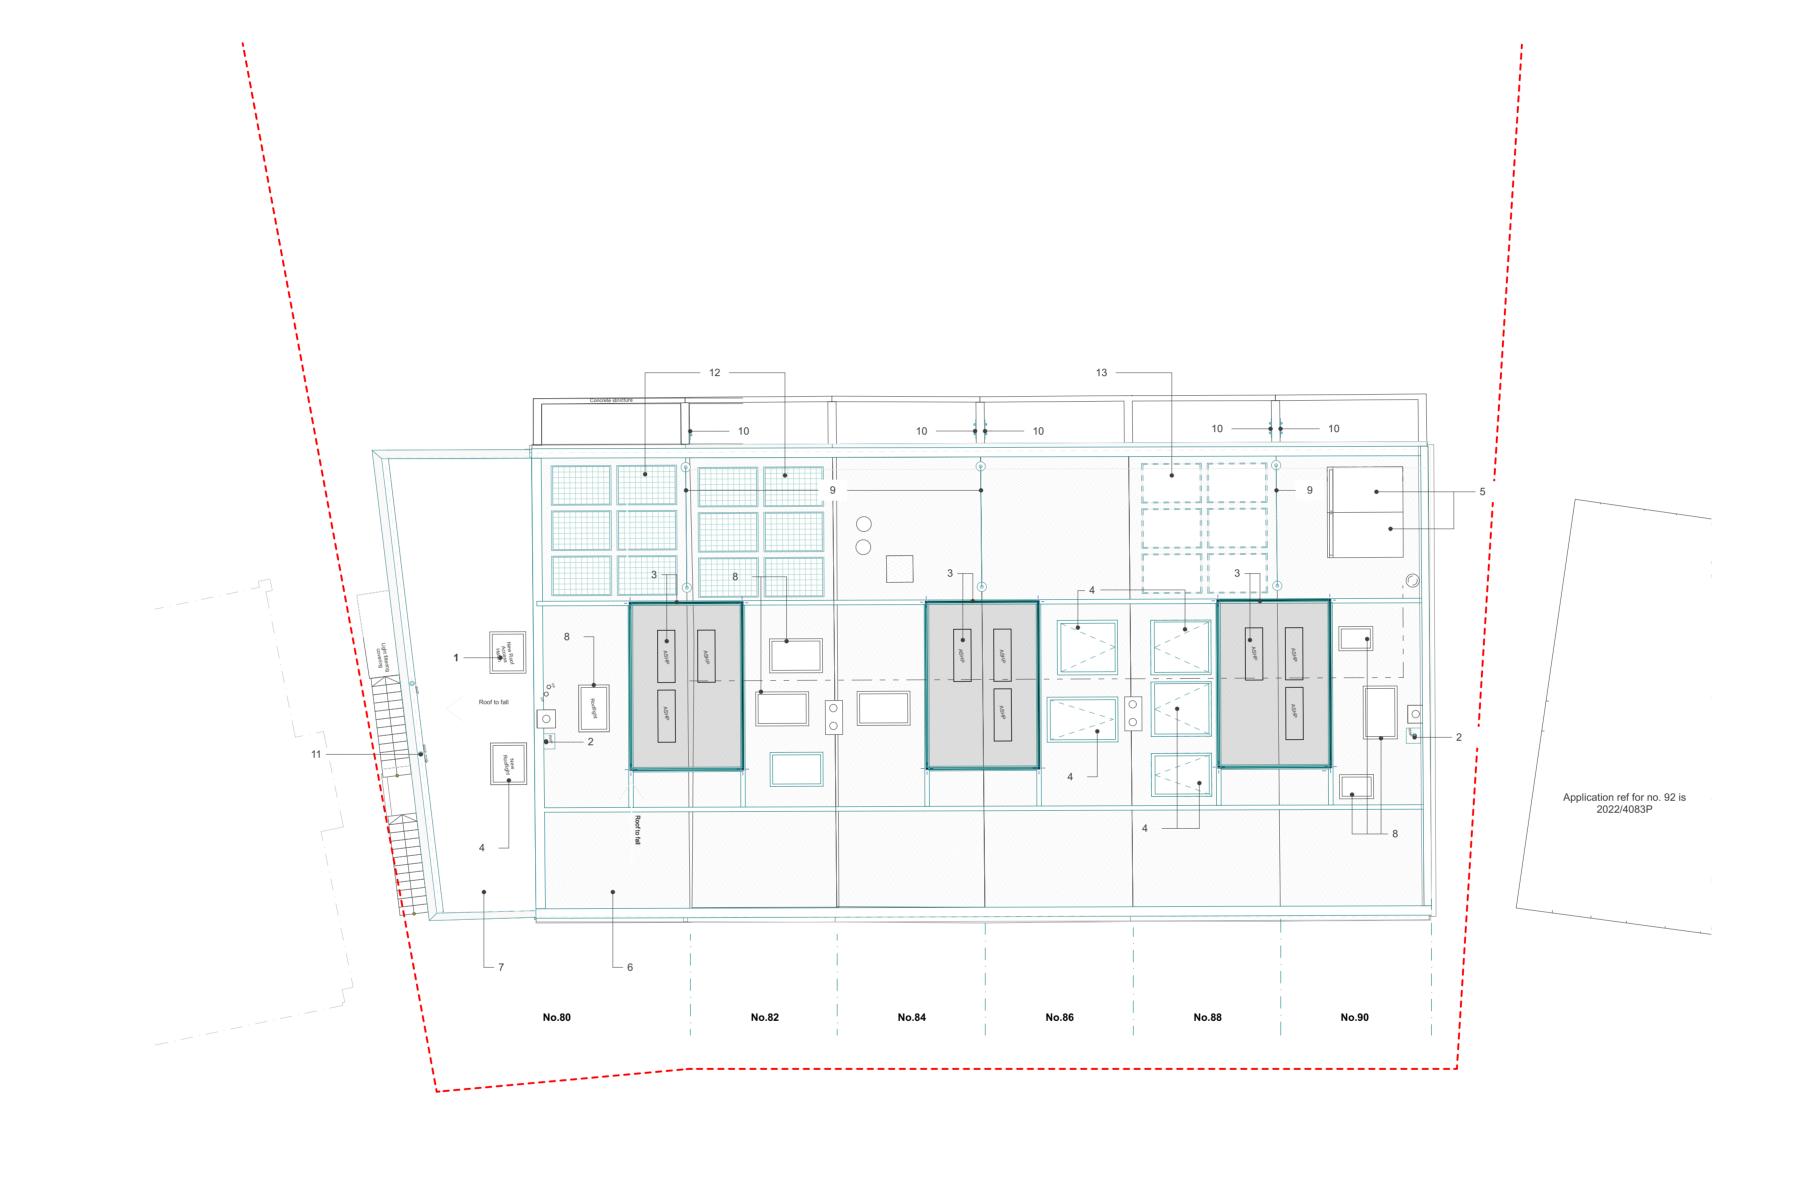Key

Existing

Proposed

1. Roof access at No80 SHP. Internal roof hatch with retractible ladder in circulation areas, to ALL residential units
2. Existing 2no. RWP

New air pumps concealed behind metal louvered enclosure. On new metal structure decoupled from existing roof. See Structural

Engineer details

4. New rooflight

5. Existing roof insulated to achieve U-Value of 0.15 W/M²K in line with Building Regulations

7. New roof extension

8. Existing rooflight reinstated following insulation of existing roof Location and sizes of existing rooflights assumed at this stage

Mansafe System


10. Ladder securing point for safe roof access 11. New Rain Water Pipe to no.80 roof extension

12. New solar panels
13. New solar panels at no.88 - submitted under a different application ref. PP-12653155v1

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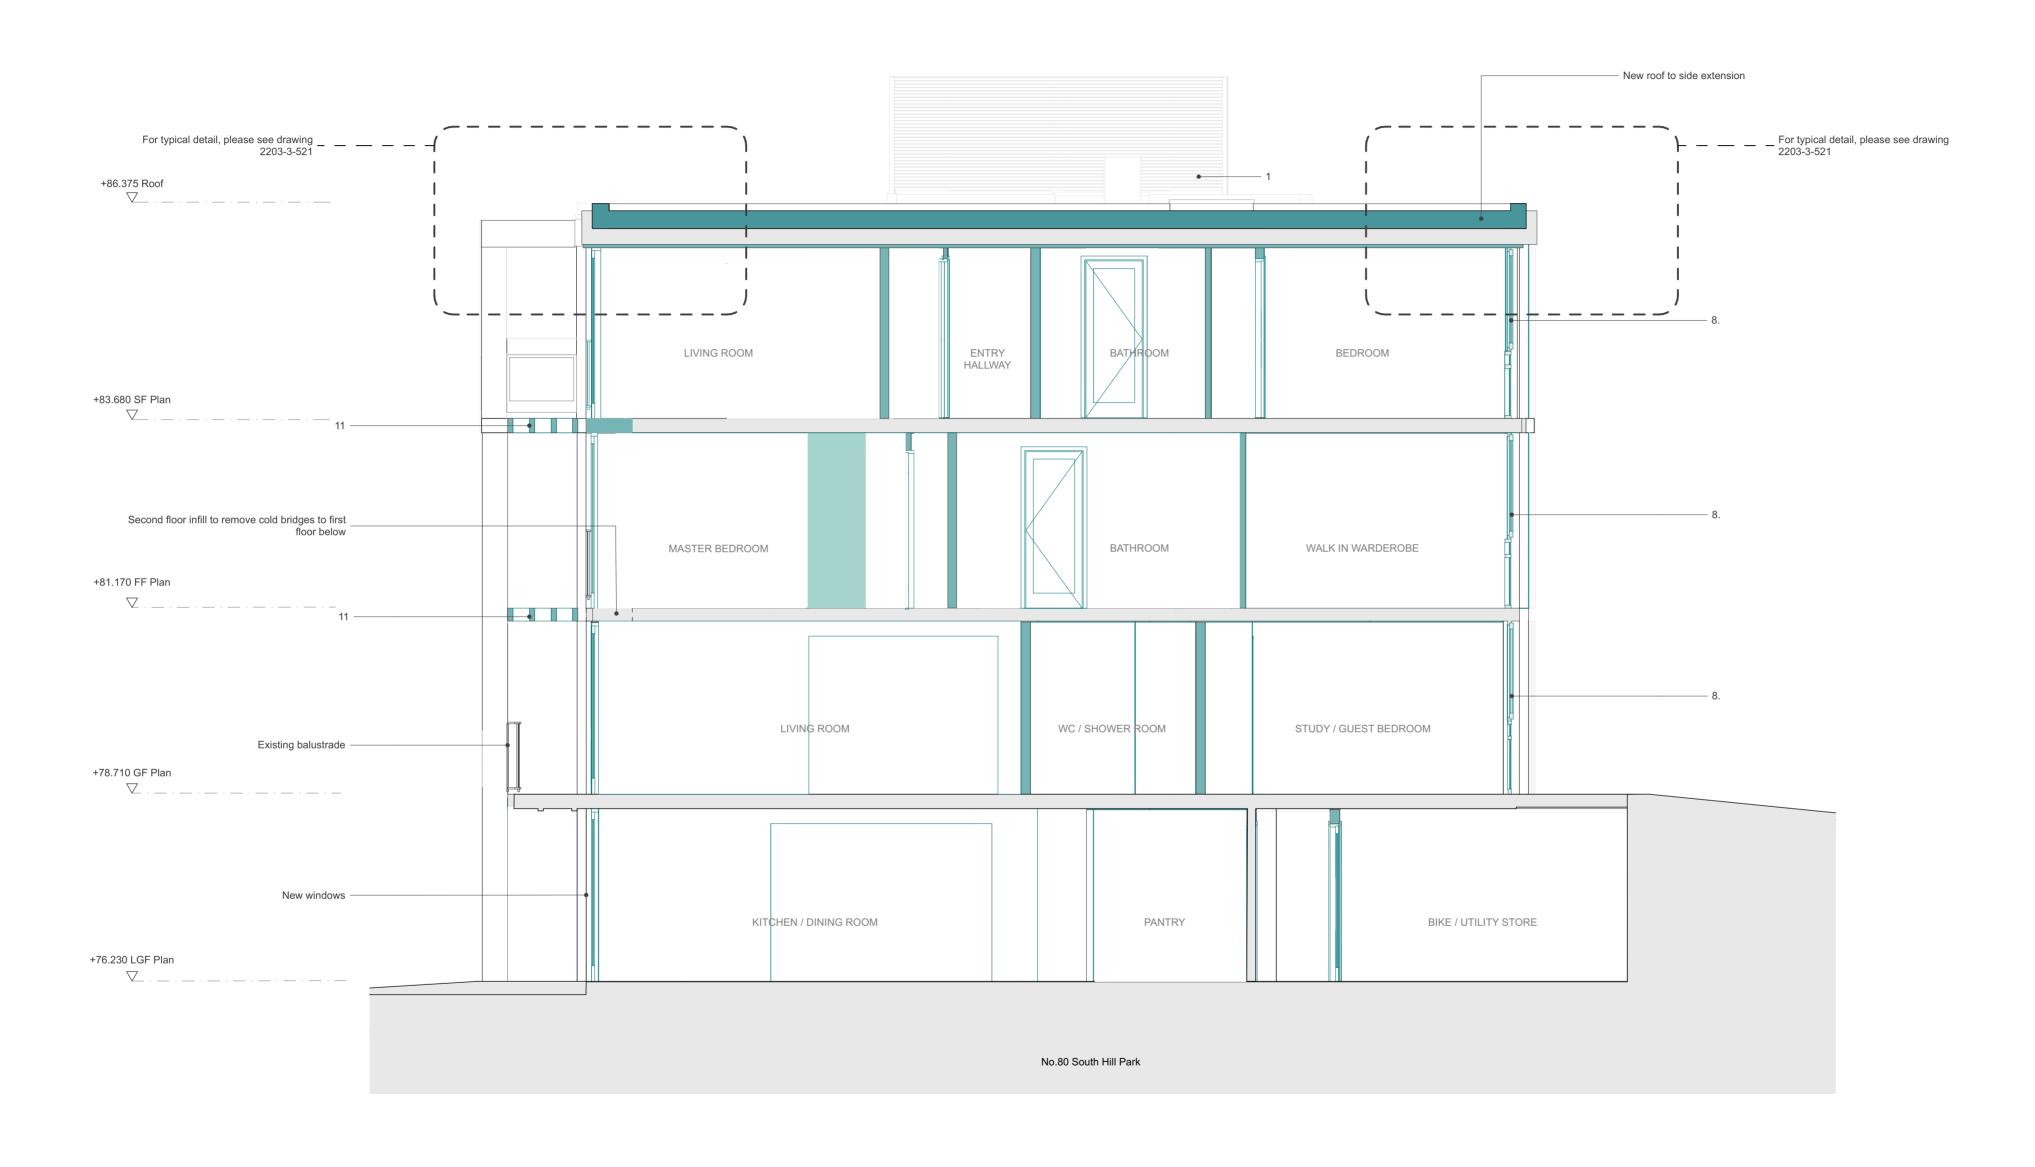
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Project: 2203 No80 South Hill Park Client: South Hill Park Drawing: Proposed Roof Plan Wider Terrace

Drawing no: 2203-3-106 Status: Stage 3 Scale: 1:100@A2 Date: 22/12/2023

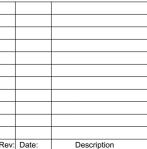

201 PROPOSED SECTION A NO. 80 SOUTH HILL PARK



information.

2. Terrace roof upstand

3. New roof extension to align with floors below. Insulated render finish to match floors below

4a. Insulated render finish to existing flank wall to match existing brick colour 4b. Insulated render finish to existing flank wall to align and match existing slab

5. New steel staircase and strengthening structure to retained concrete landings

Refer to fabric improvement strategy from the M+E consultant and structural engineers to side of no.80 6. Retained concrete landing7. External MVHRs

1. Acoustic louvered enclosure to ASHPs

8. New hardwood double glazed timber windows/ doors. Timber finish to match across terrace
9. Metal flashing to window cill
10. Protective metal capping to rear concrete beams to match roof edge flashing
11. Existing rotten brise soleis and timber post reinstated
12. New metal railing to match existing
13. Edge flashing to new no80 extension
14. Existing cast iron spiral stairs and metal railings refurbished
15. New concrete edge beam to no80 extension to match existing terrace edge beam

8. New hardwood double glazed timber windows/ doors. Timber finish to match

16. Existing chimney refurbished



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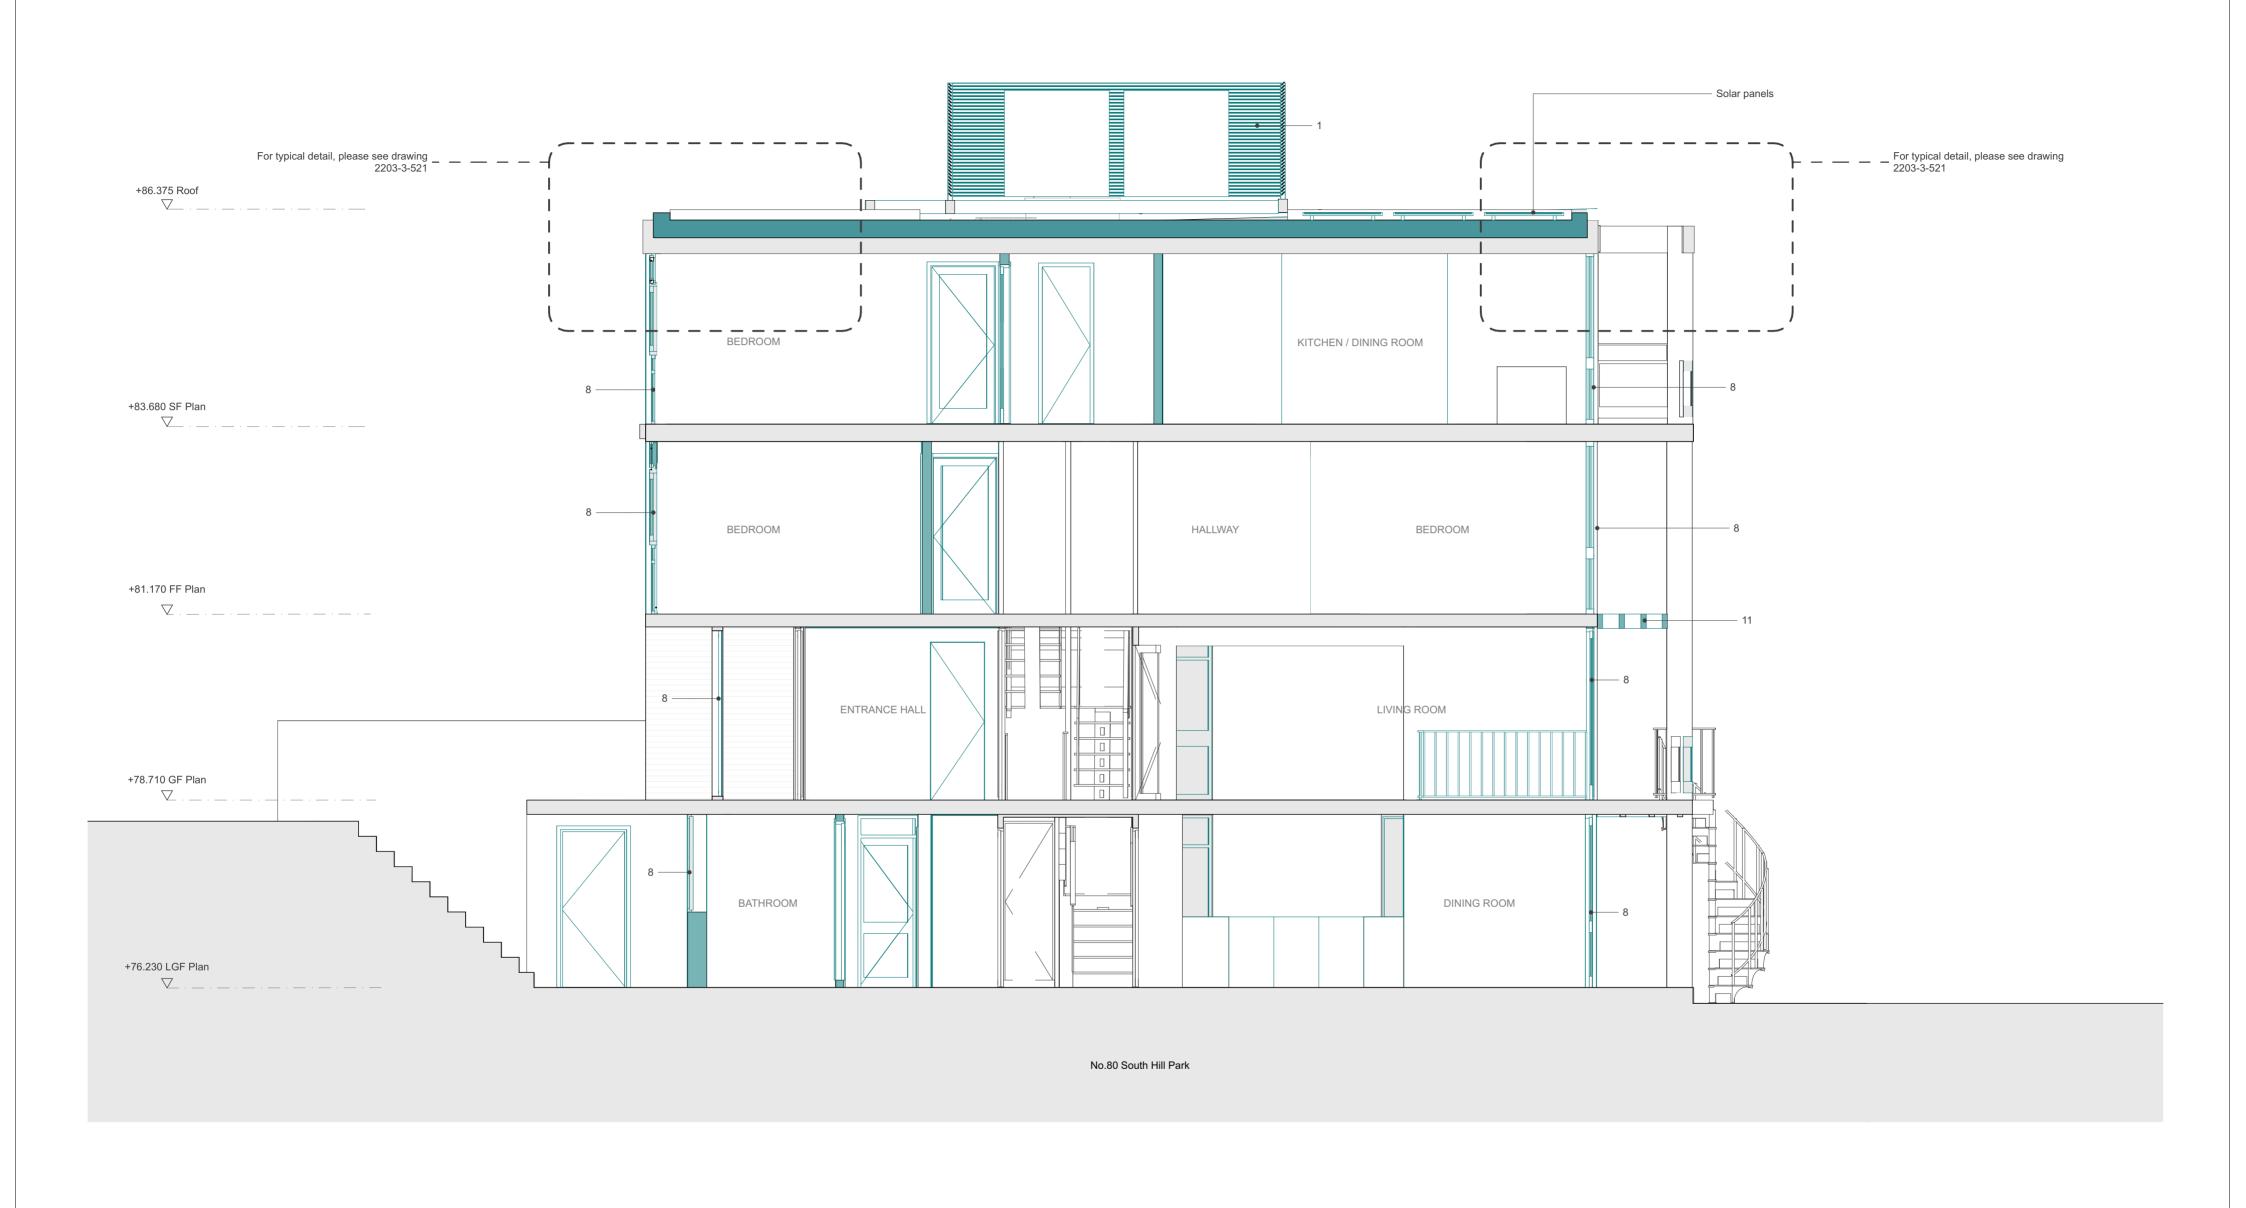
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Project: 2203 No80 South Hill Park Client: South Hill Park Drawing: Proposed Section A Drawing no: 2203-3-201

Scale: 1:50@A2 Date: 22/12/2023 citizens **design** bureau t: 0203 095 9732 w: www.citizensdesignb

Status: Stage 3



202 PROPOSED SECTION B NO. 80 SOUTH HILL PARK



Proposed

Notes:

Key

Refer to fabric improvement strategy from the M+E consultant and structural engineers

1. Acoustic louvered enclosure to ASHPs 2. Terrace roof upstand

3. New roof extension to align with floors below. Insulated render finish to match floors below

4a. Insulated render finish to existing flank wall to match existing brick colour 4b. Insulated render finish to existing flank wall to align and match existing slab

5. New steel staircase and strengthening structure to retained concrete landings to side of no.80

6. Retained concrete landing
7. External MVHRs

8. New hardwood double glazed timber windows/ doors. Timber finish to match

8. New hardwood double glazed timber windows/ doors. Timber finish to match across terrace
9. Metal flashing to window cill
10. Protective metal capping to rear concrete beams to match roof edge flashing
11. Existing rotten brise soleis and timber post reinstated
12. New metal railing to match existing
13. Edge flashing to new no80 extension
14. Existing cast iron spiral stairs and metal railings refurbished
15. New concrete edge beam to no80 extension to match existing terrace edge

16. Existing chimney refurbished


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Project: 2203 No80 South Hill Park Client: South Hill Park Drawing: Proposed Section B

Drawing no: 2203-3-202 Status: Stage 3 Scale: 1:50@A2 Date: 22/12/2023



203 PROPOSED SECTION C NO. 80 SOUTH HILL PARK

Key Existing

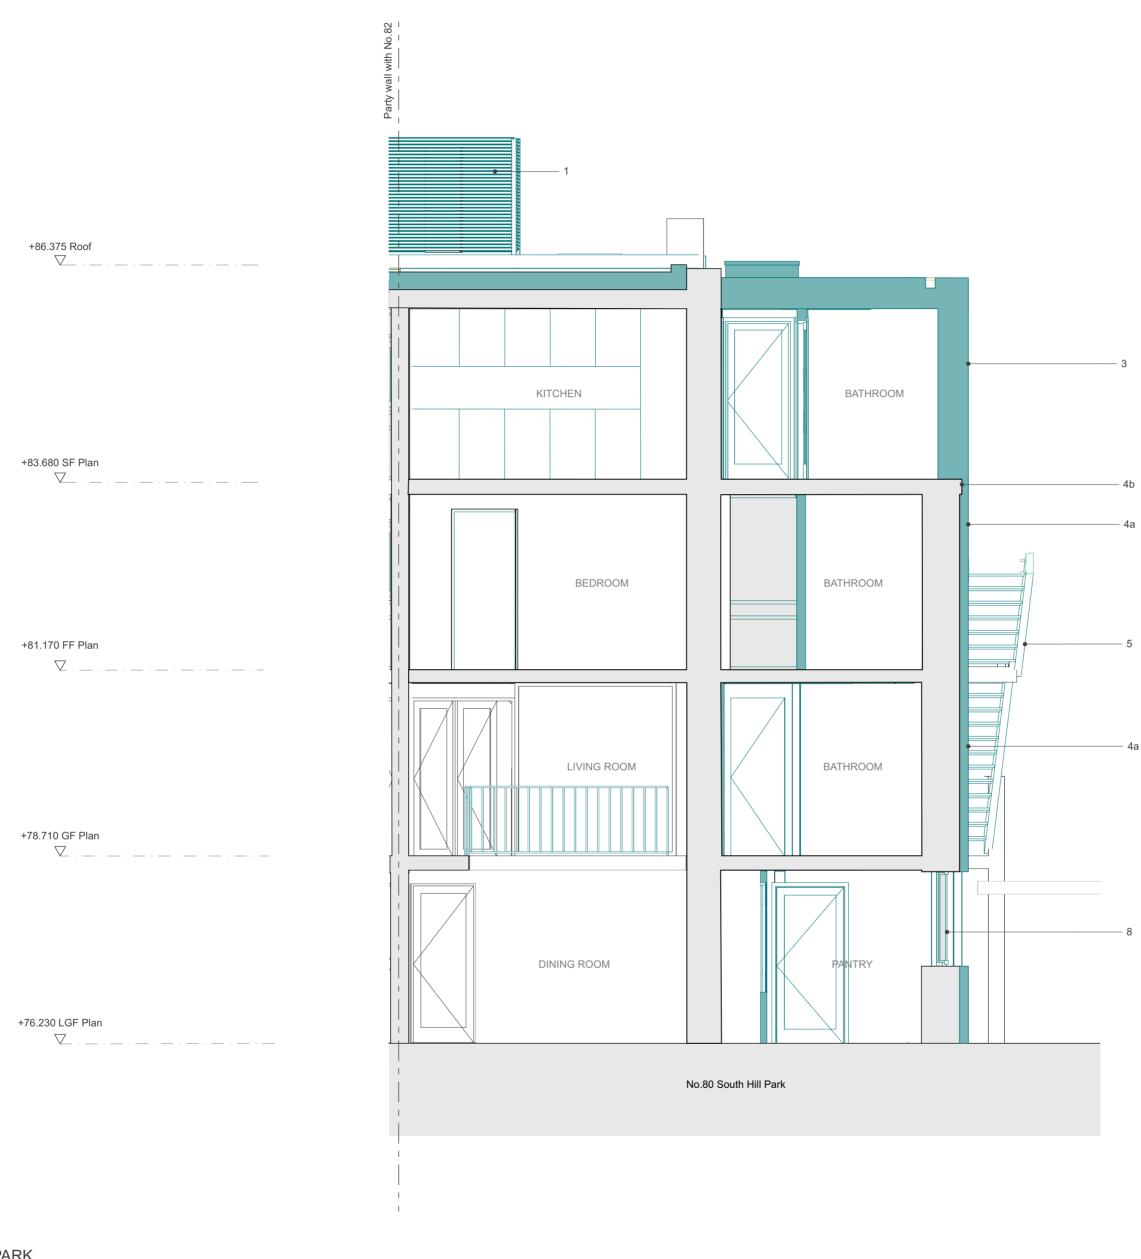Proposed

Notes: Refer to fabric improvement strategy from the M+E consultant and structural engineers information. Acoustic louvered enclosure to ASHPs
 Terrace roof upstand

3. New roof extension to align with floors below. Insulated render finish to match floors below

4a. Insulated render finish to existing flank wall to match existing brick colour4b. Insulated render finish to existing flank wall to align and match existing slab

5. New steel staircase and strengthening structure to retained concrete landings

to side of no.80 6. Retained concrete landing 7. External MVHRs

8. New hardwood double glazed timber windows/ doors. Timber finish to match

8. New hardwood double glazed timber windows/ doors. Timber finish to match across terrace

9. Metal flashing to window cill

10. Protective metal capping to rear concrete beams to match roof edge flashing

11. Existing rotten brise soleis and timber post reinstated

12. New metal railing to match existing

13. Edge flashing to new no80 extension

14. Existing cast iron spiral stairs and metal railings refurbished

15. New concrete edge beam to no80 extension to match existing terrace edge beam

16. Existing chimney refurbished




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Project: 2203 No80 South Hill Park Client: South Hill Park Drawing: Proposed Section C Drawing no: 2203-3-203 Status: Stage 3 Scale: 1:50@A2 Date: 22/12/2023



301 PROPOSED FRONT ELEVATION NO. 80 SOUTH HILL PARK

Key

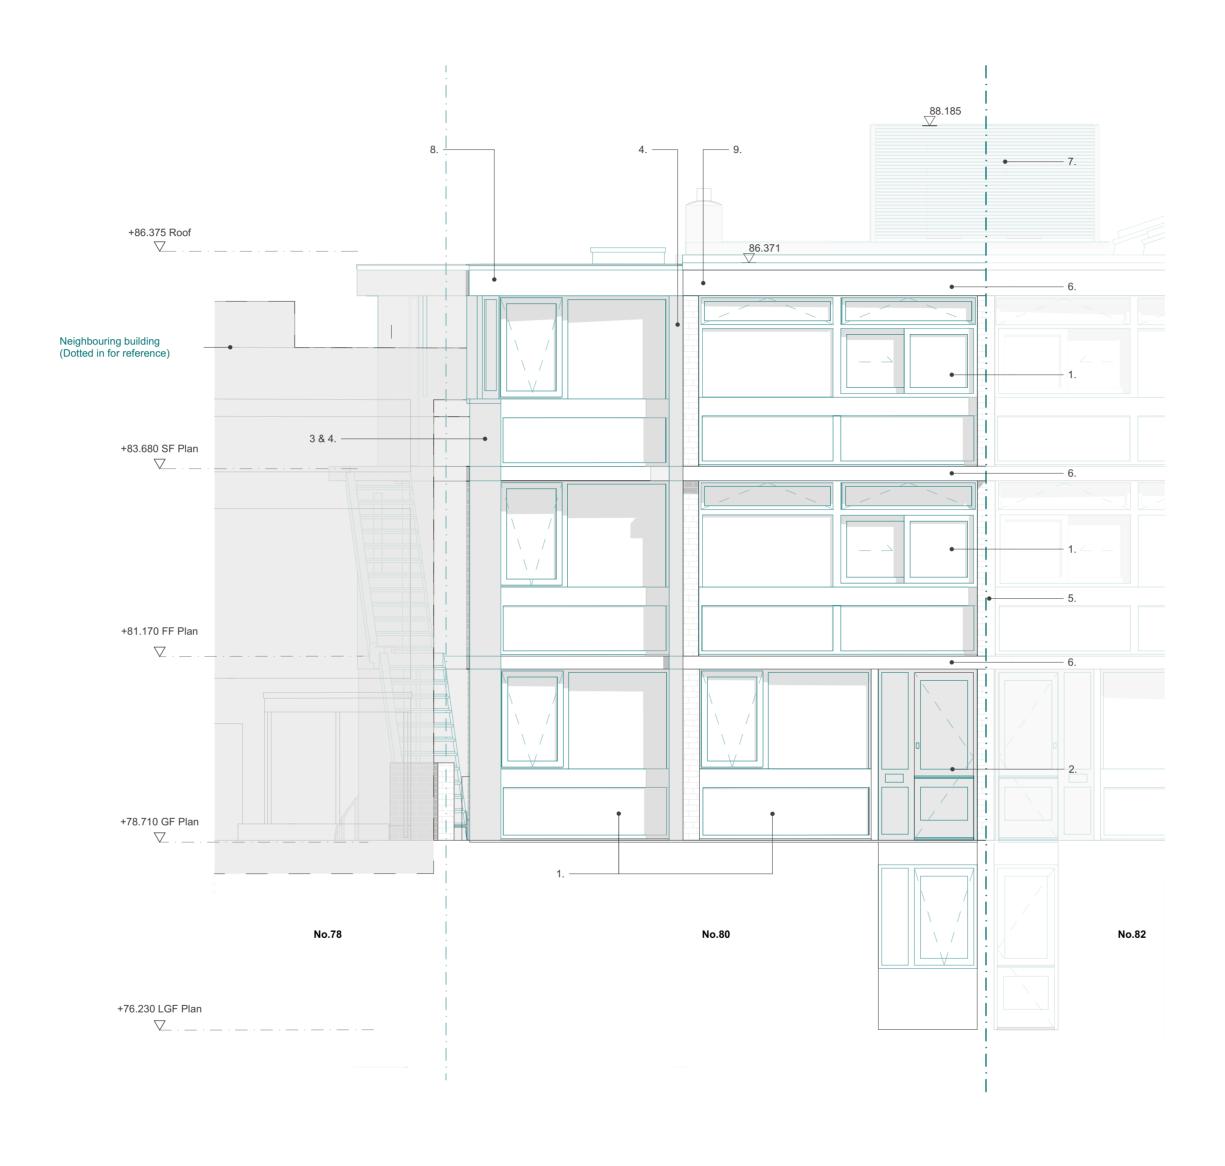Proposed

Notes: Refer to fabric improvement strategy from the M+E consultant and structural engineers information. 1. New hardwood timber framed windows to match original design from 1950s, to

improve the existing thermal building performances

2. New hardwood timber framed door and side fixed panel to match original design from

1950s, to improve the existing thermal building performances
3. Permeable insulation to un-insulated flank wall, with wood-fibre batts fixed to the mortar courses masonry and finished with a permeable lime render, to improve the existing thermal building performances. Permeable render finish to match brick colour of lighter bricks and exposed elabs.

lighter bricks and exposed slabs Note: Thermally, the existing uninsulated flank wall is a significant problem in terms of internal comfort, energy and cost efficiency as well as risk to the existing fabric because of current condensation 4. Permeable render finish on wood wool panel to brickwork return, reduced thickness

to max. 30mm overall. Lime render finish to match brick colour of lighter bricks

Existing party wall




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Project: 2203 No80 South Hill Park Client: South Hill Park Drawing: Proposed Front Elevation Drawing no: 2203-3-301 Status: Stage 3 Scale: 1:50@A2 Date: 22/12/2023



301.1 PROPOSED FRONT ELEVATION IN CONTEXT NO. 80 SOUTH HILL PARK

Proposed Refer to fabric improvement strategy from the M+E consultant.

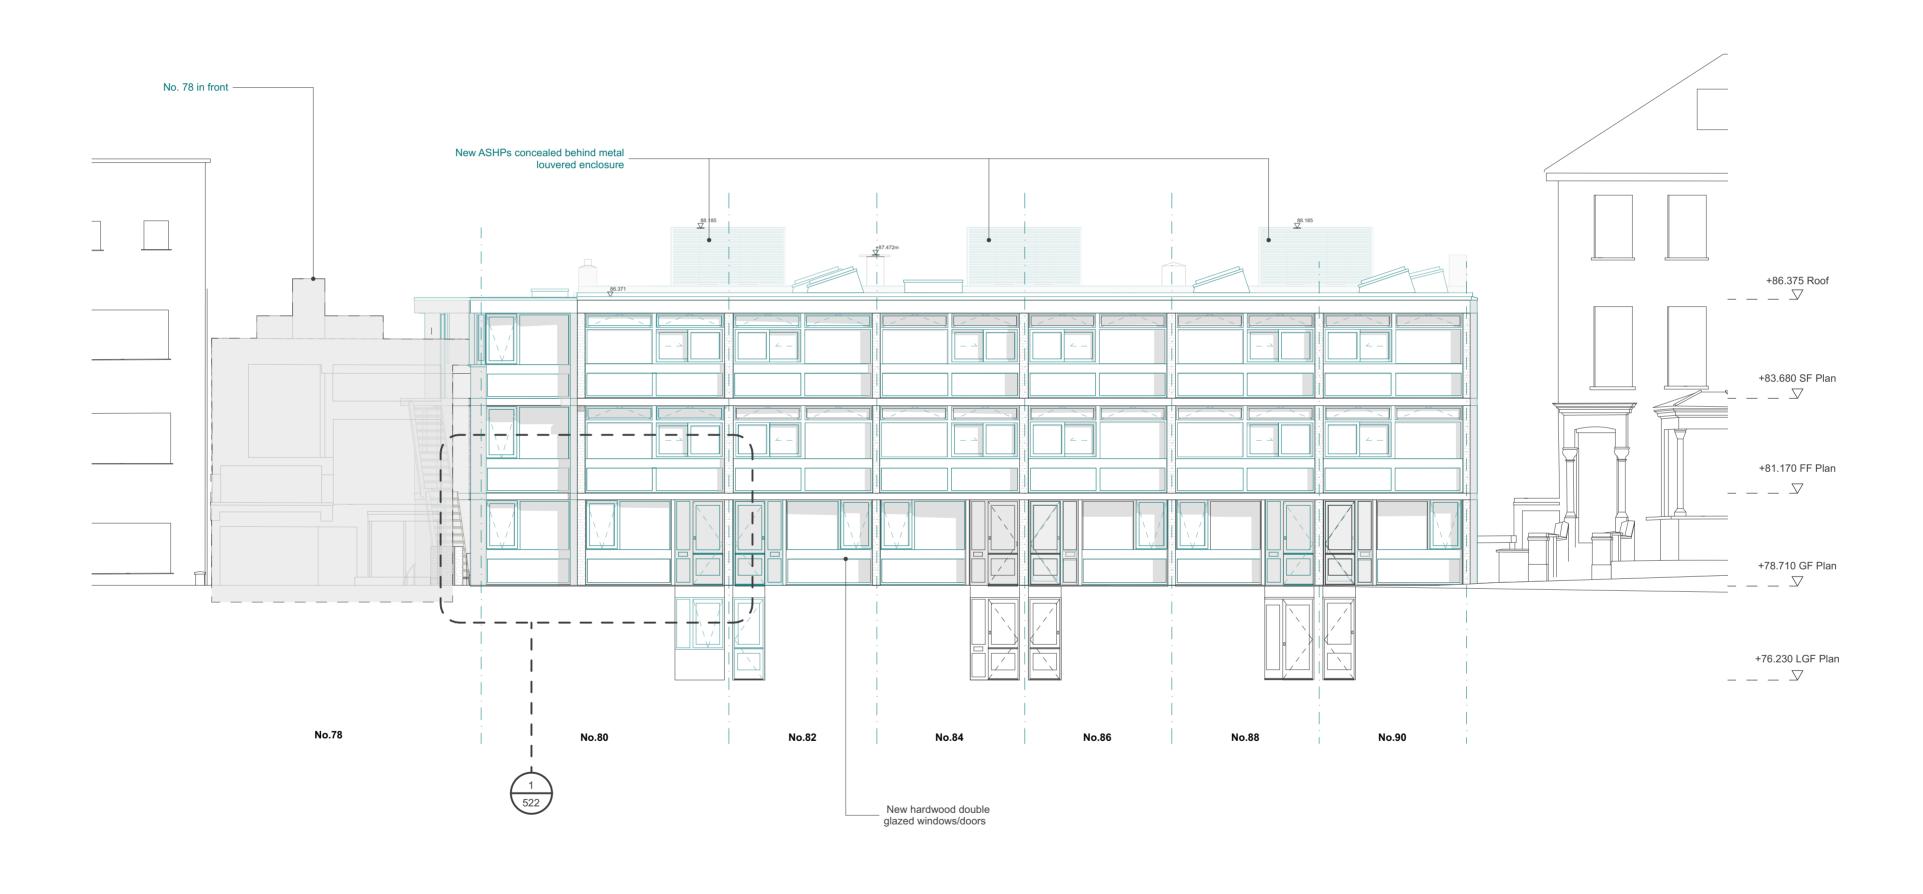Key

Existing



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0 1 2 3m

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Project: 2203 No80 South Hill Park Client: South Hill Park Drawing: 301.1 Proposed Front Elevation in Context Drawing no: 2203-3-Rev: Date:

Scale: 1:100@A2 Date: 22/12/2023 citizens design bureau
Ground Floor Units 1 & 3
6 Westgate Street, London, E8 3RN t: 0203 095 9732 w: www.citizensdesignbureau.net

Status: Stage 3



302 PROPOSED REAR ELEVATION NO. 80 SOUTH HILL PARK

Key Existing Proposed Notes:

Refer to fabric improvement strategy from the M+E consultant and structural engineers information.

1. Acoustic louvered enclosure to ASHPs

2. Terrace roof upstand

3. New roof extension to align with floors below. Insulated render finish to match floors below

4a. Insulated render finish to existing flank wall to match existing brick colour 4b. Insulated render finish to existing flank wall to align and match existing slab

5. New steel staircase and strengthening structure to retained concrete landings to side of no.80 6. New hardwood double glazed timber windows/ doors to match existing original 7. Protective metal capping to rear concrete beams to match roof edge flashing
8. Existing rotten brise soleis and timber post reinstated
9. New metal railing to match existing
10. Roof edge flashing to new no80 extension
11. Existing cast iron spiral stairs and metal railings refurbished
12. New concrete edge beam to no80 extension to match existing terrace edge

13. Existing chimney refurbished Existing concrete beam/ slab
 Original terrace balustrades reinstated




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Rev: Date:

Project: 2203 No80 South Hill Park Client: South Hill Park Drawing: Proposed Rear Elevation Drawing no: 2203-3-302 Status: Stage 3 Scale: 1:50@A2 Date: 22/12/2023



302.1 PROPOSED REAR ELEVATION IN CONTEXT NO. 80 SOUTH HILL PARK

Existing
Proposed
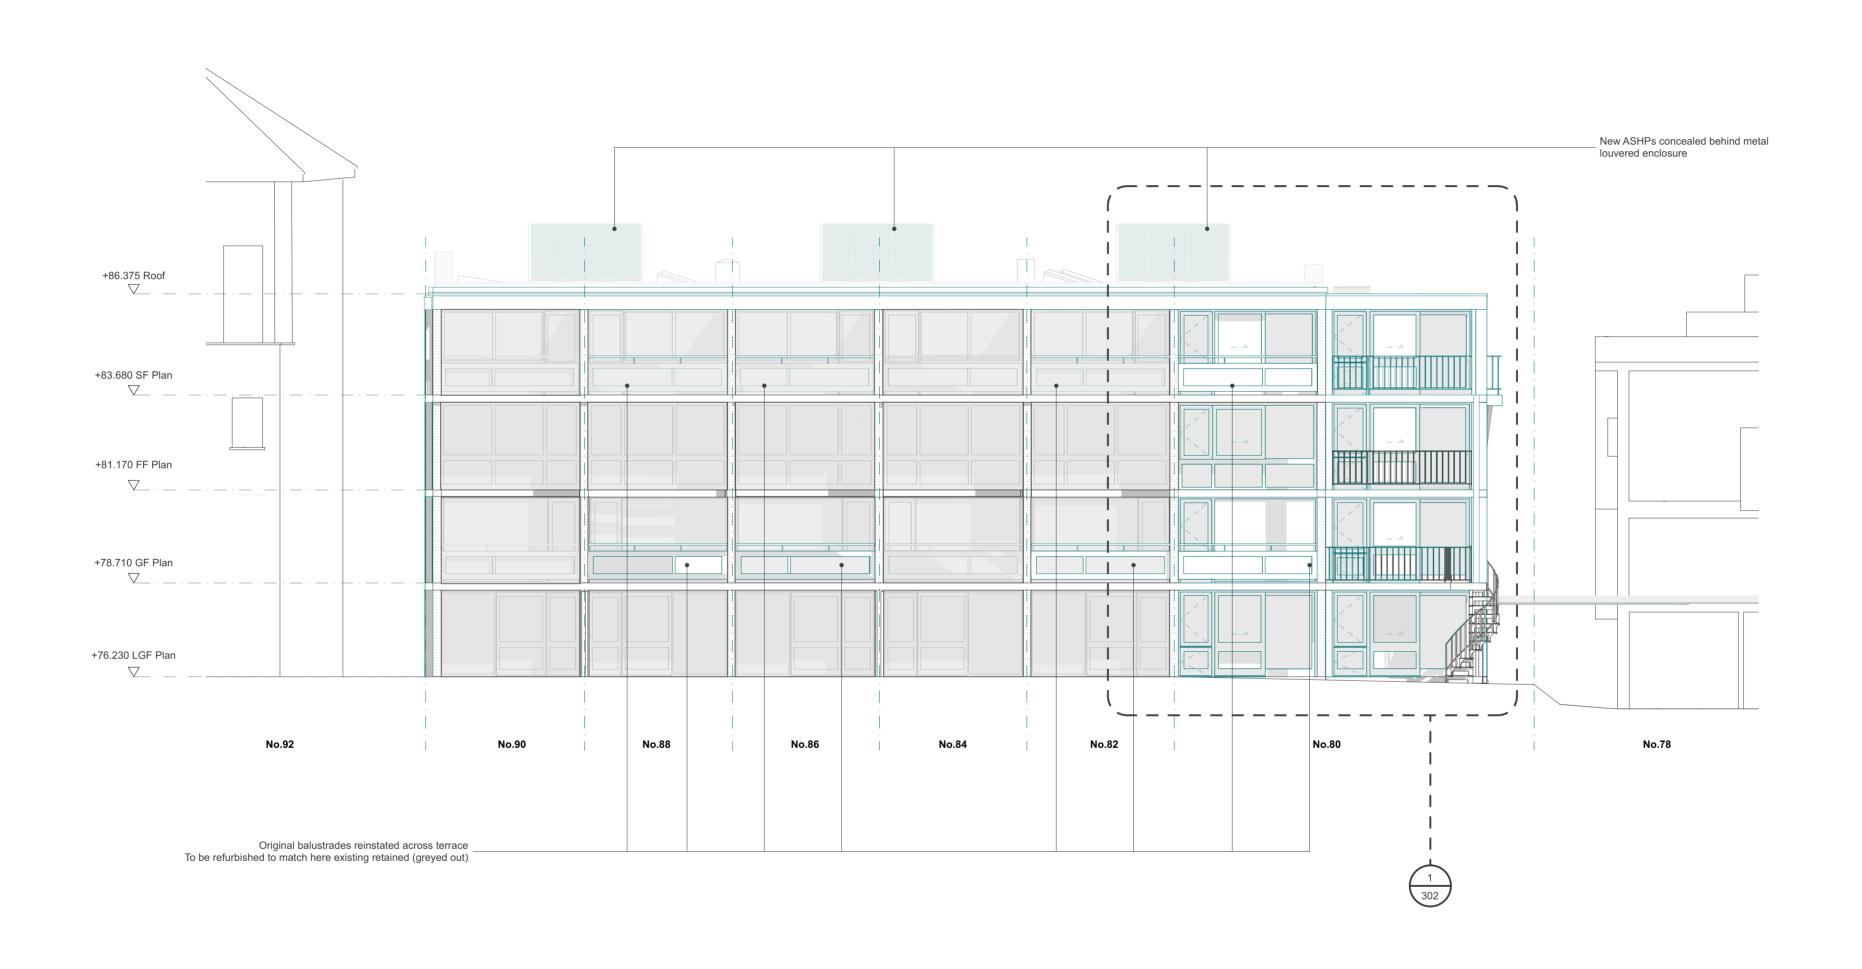
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0 1 2 3m

Rev: Date:

Project: 2203 No80 South Hill Park
Client: South Hill Park
Drawing: Proposed Rear Elevation in
Context


Drawing no: 2203-3-302.1
Rev: Status: Stage 3
Scale: 1:100@A2 Date: 22/12/2023

Citizens design bureau
Ground Floor Units 1 & 3
6 Westgate Street, London, £8 3RN

t: 0203 095 9732 w: www.citizensdesignbureau.net

Notes:

Refer to fabric improvement strategy from the M+E consultant and structural engineers information.

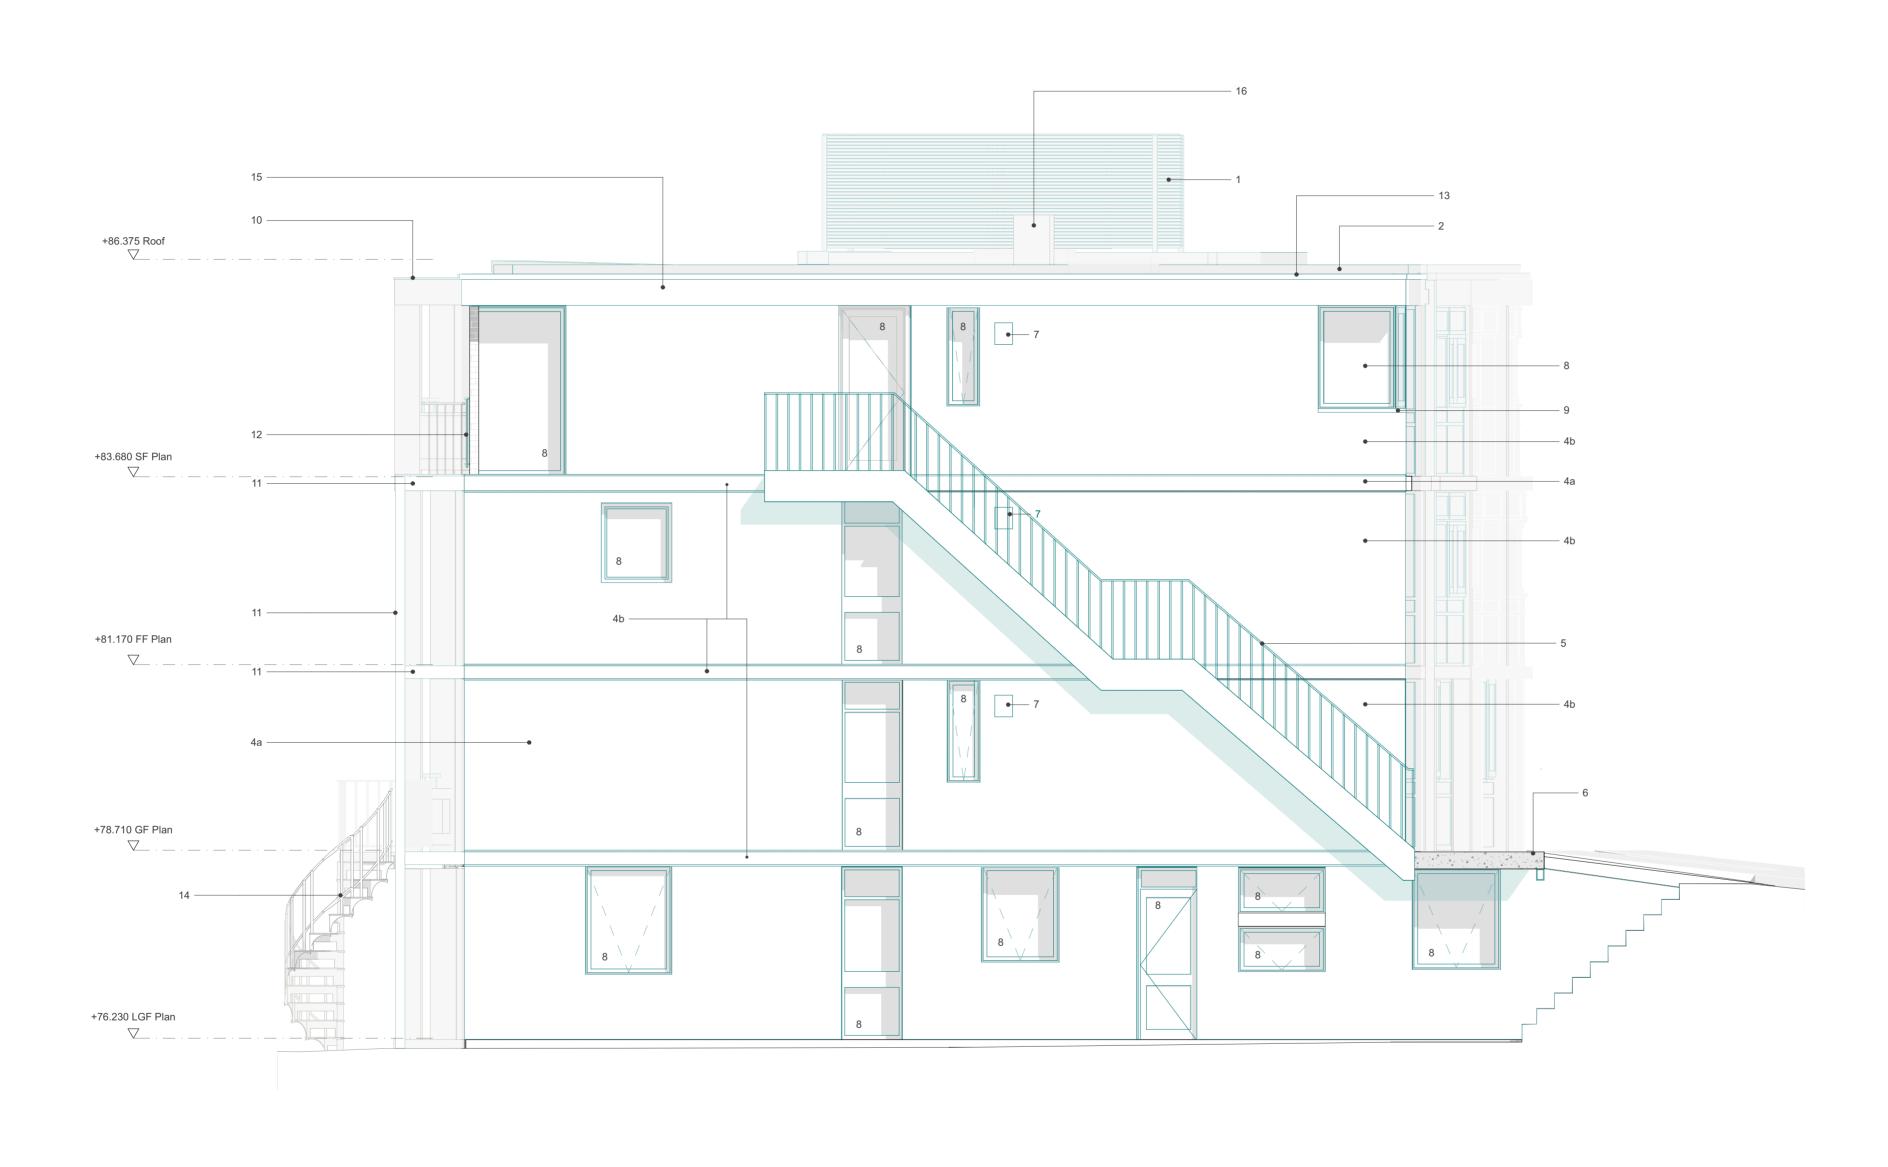

303 PROPOSED SIDE ELEVATION NO. 80 SOUTH HILL PARK

Existing Proposed

Refer to fabric improvement strategy from the M+E consultant and structural engineers information.

Key

Notes:

Acoustic louvered enclosure to ASHPs
 Terrace roof upstand
 New roof extension to align with floors below. Insulated render finish to match

floors below

4a. Insulated render finish to existing flank wall to match existing brick colour

4b. Insulated render finish to existing flank wall to align and match existing slab colour

5. New steel staircase and strengthening structure to retained concrete landings to side of no.80

6. Retained concrete landing 7. External MVHRs

8. New hardwood double glazed timber windows/ doors. Timber finish to match

8. New hardwood double glazed timber windows/ doors. Timber finish to match across terrace

9. Metal flashing to window cill

10. Protective metal capping to rear concrete beams to match roof edge flashing

11. Existing rotten brise soleis and timber post reinstated

12. New metal railing to match existing

13. Edge flashing to new no80 extension

Eagle hadring to not need extended.

14. Existing cast iron spiral stairs and metal railings refurbished
 New concrete edge beam to no80 extension to match existing terrace edge

beam
16. Existing chimney refurbished




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Project: 2203 No80 South Hill Park Client: South Hill Park Drawing: Proposed Side Elevation

Drawing no: 2203-3-303 Status: Stage 3 Scale: 1:50@A2 Date: 22/12/2023



Key

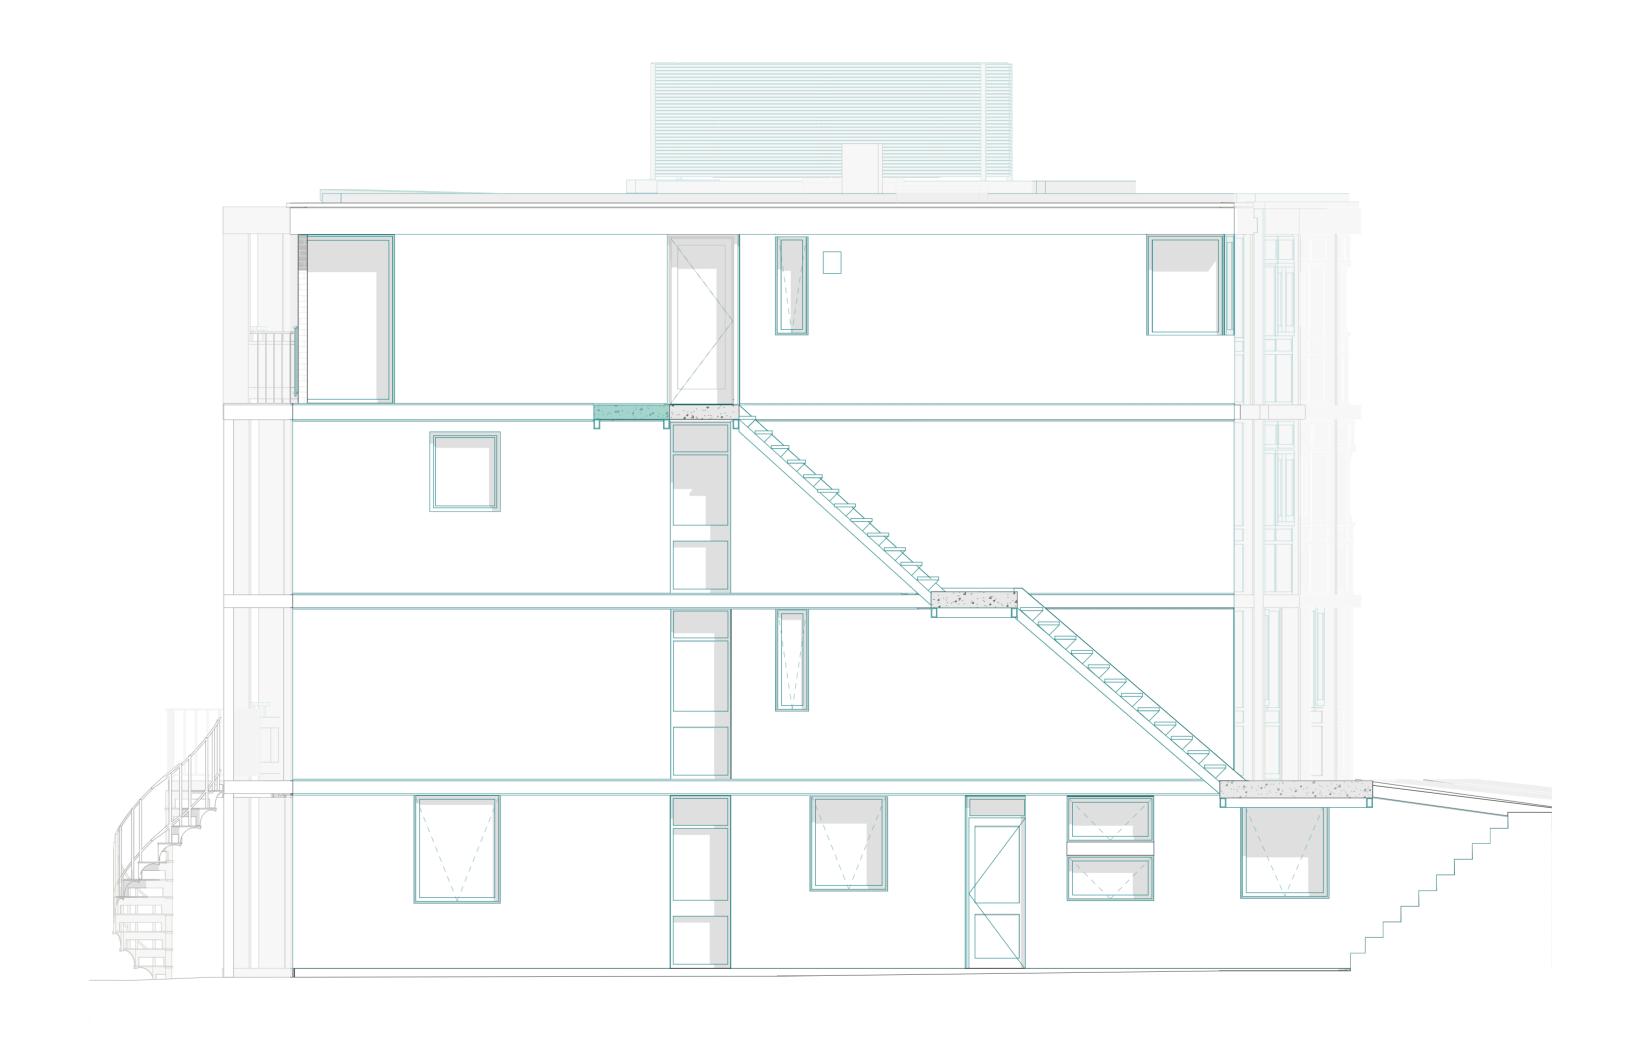Existing

Proposed

Notes:

Refer to fabric improvement strategy from the M+E consultant and structural engineers information.

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Rev:	Date:	Description	

Project: 2203 No80 South Hill Park Client: South Hill Park Drawing: External staircase section


Drawing no: 2203-3-503


Rev: Status: Stage 3


Scale: 1:50@A2 Date: 22/12/2023


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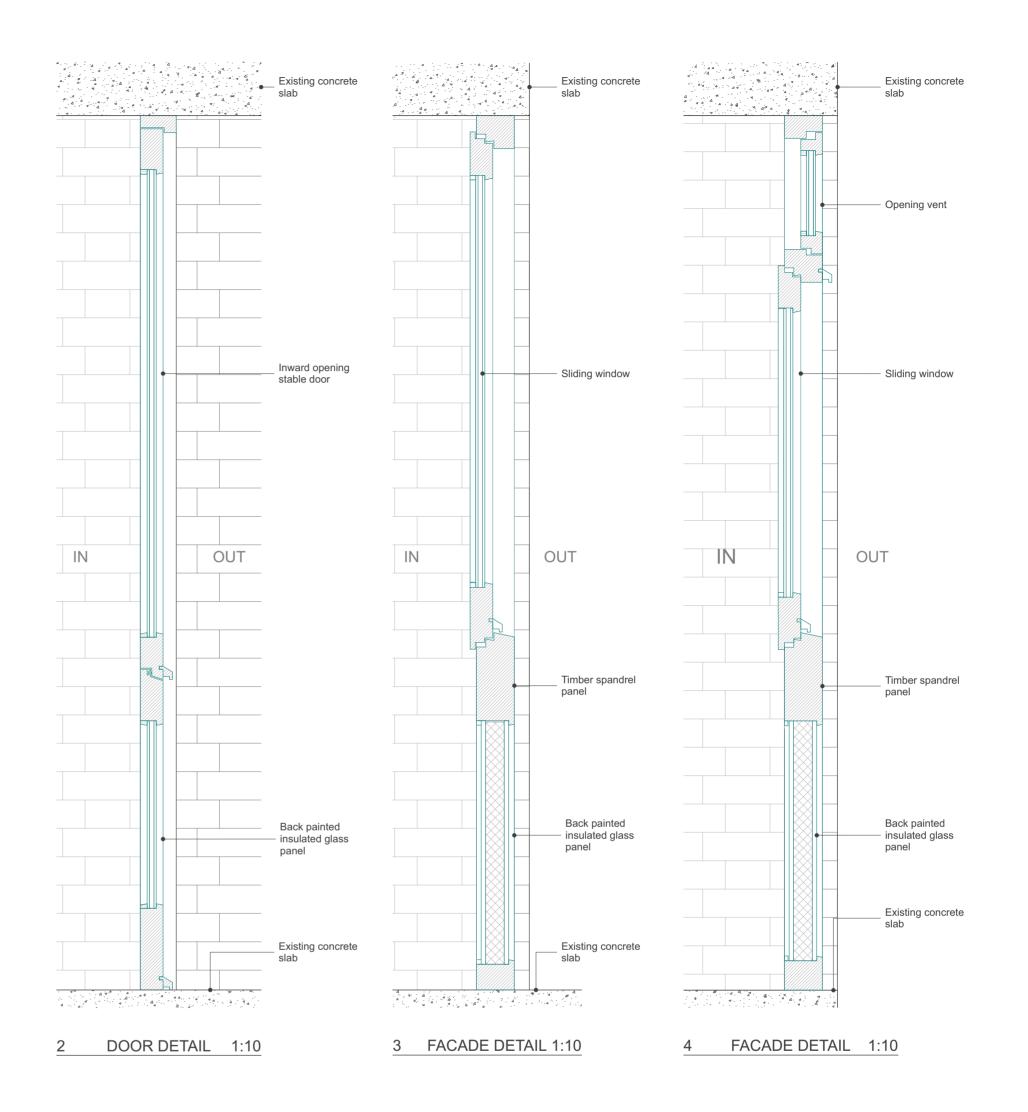




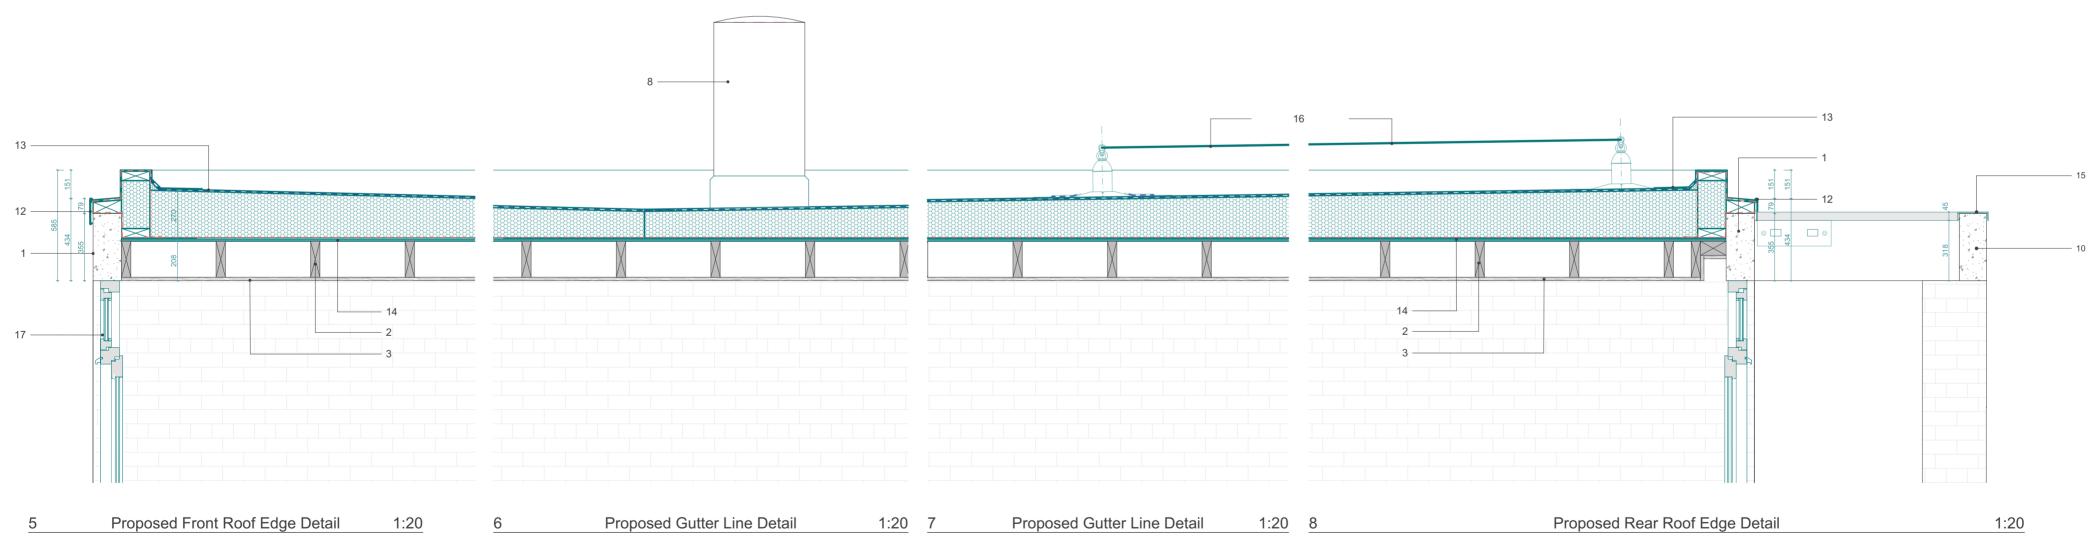

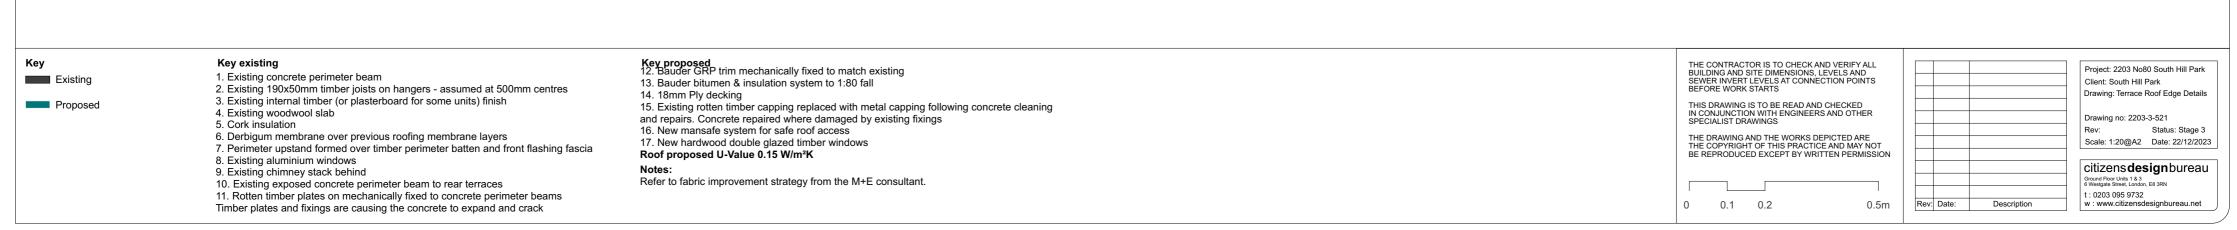

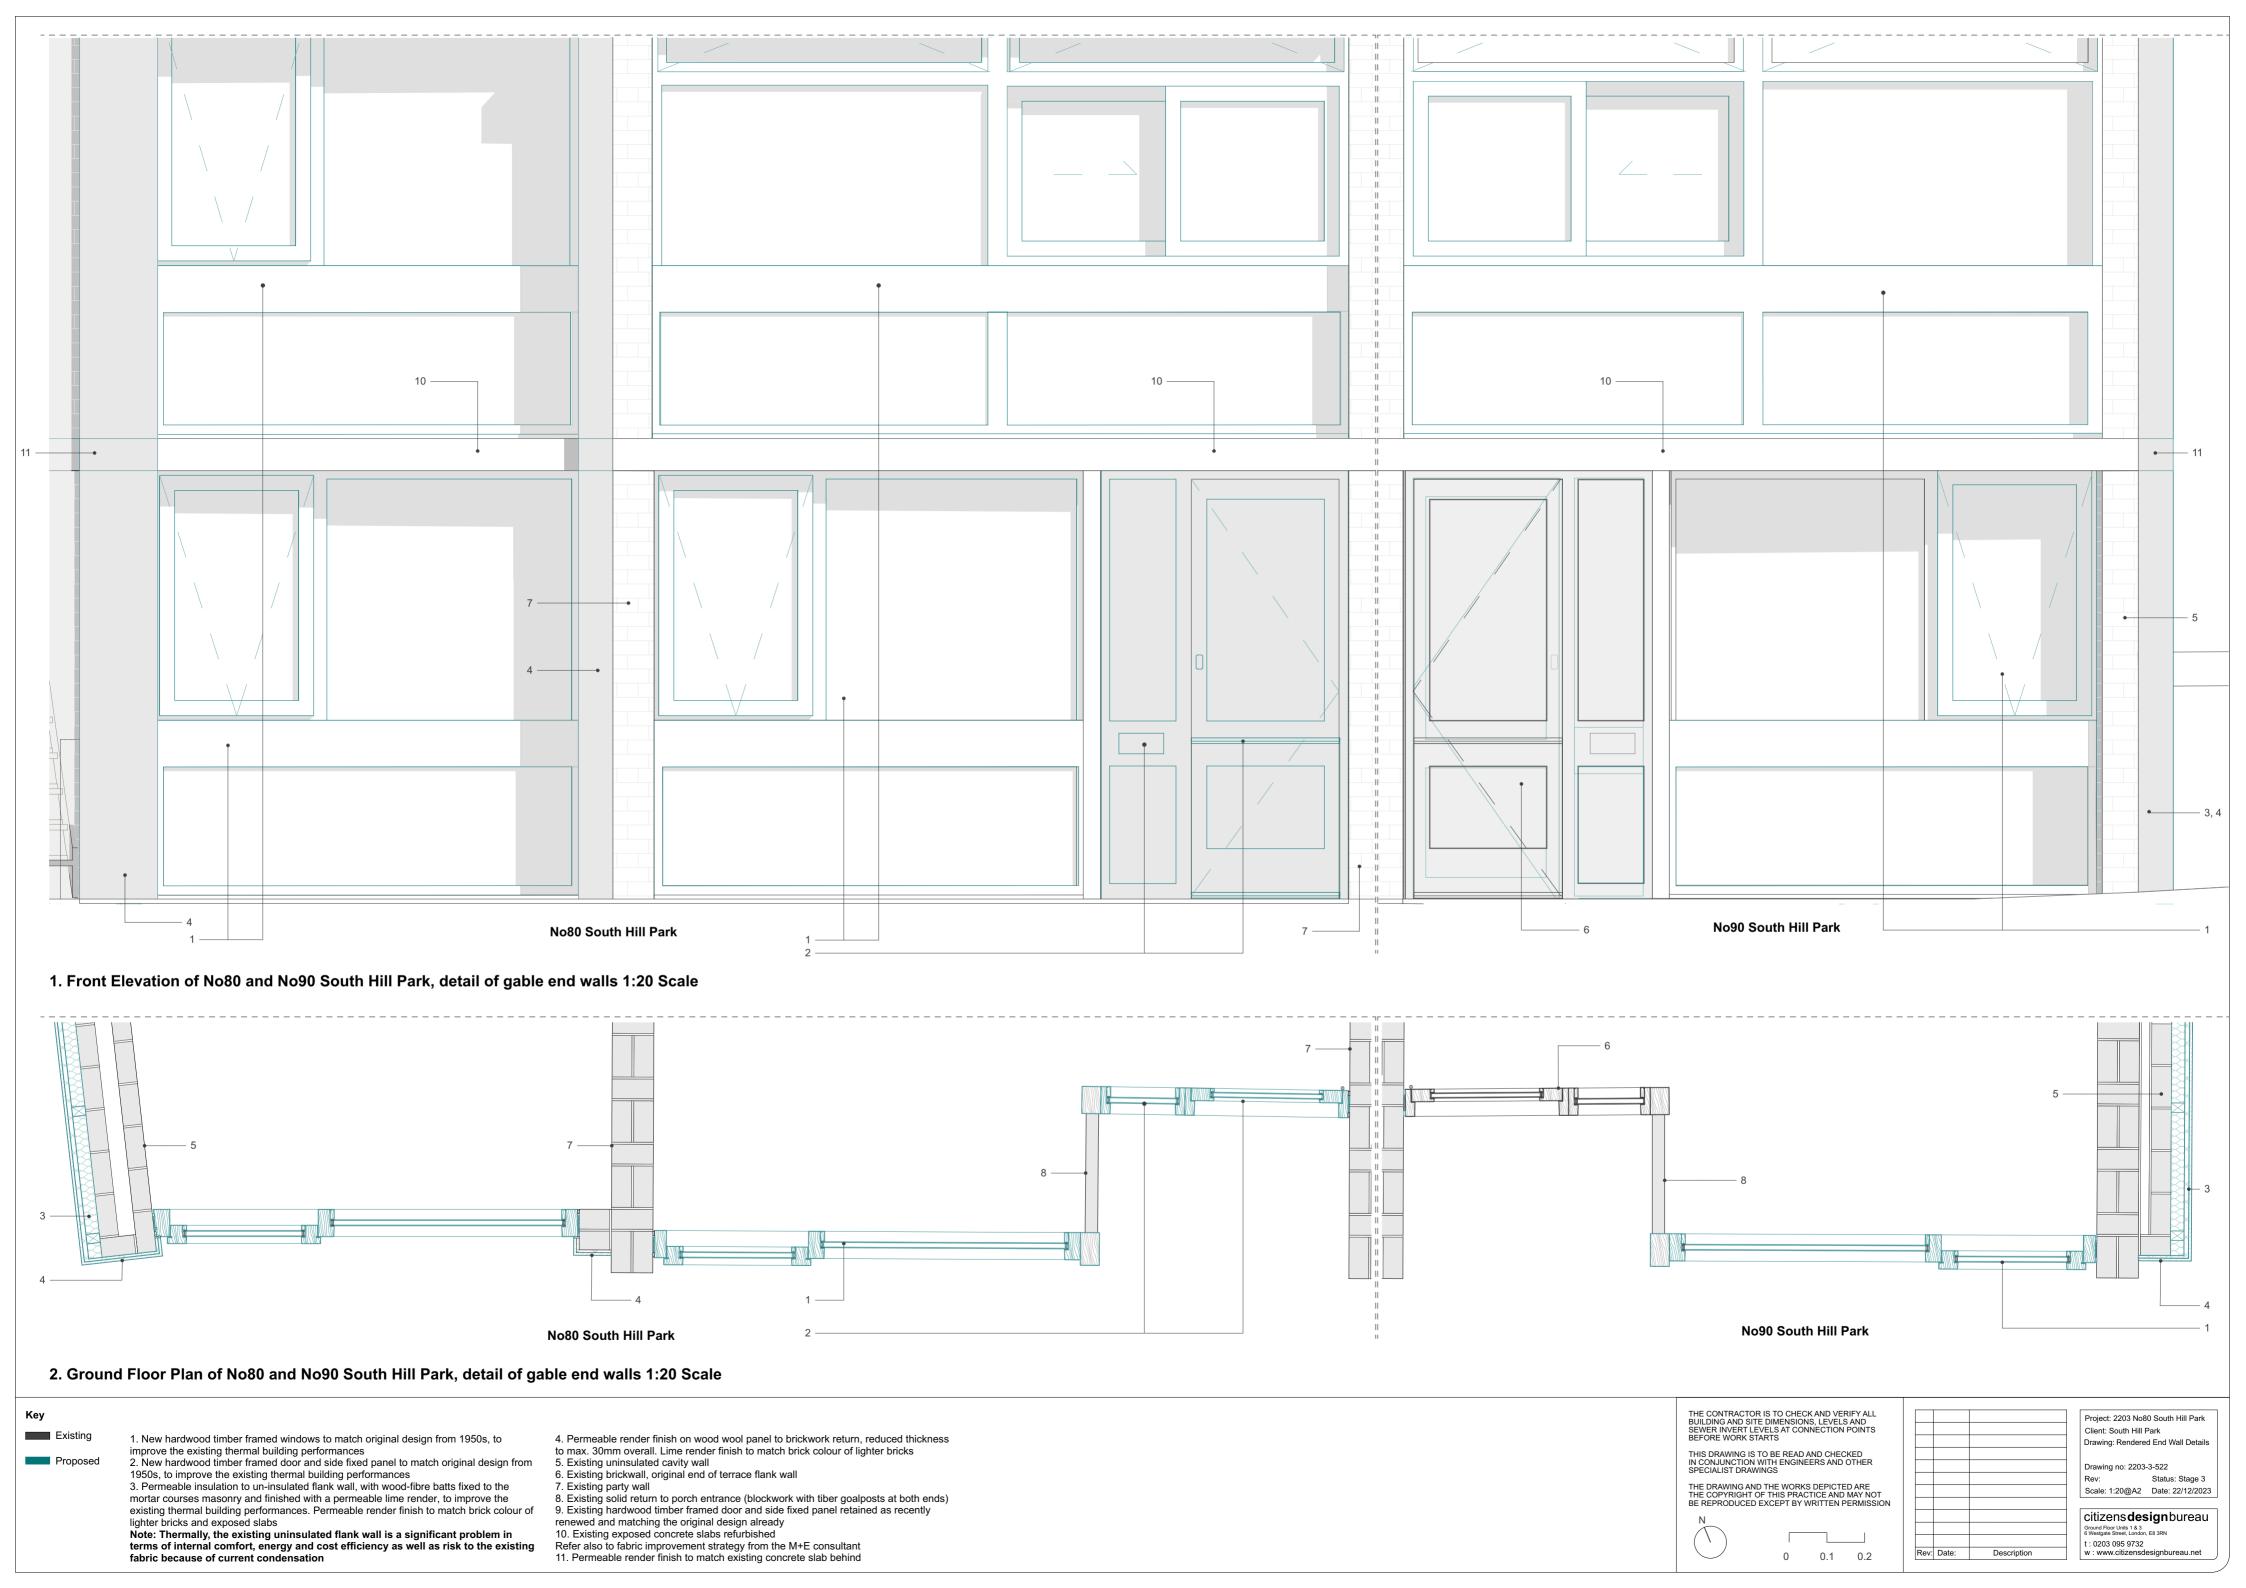

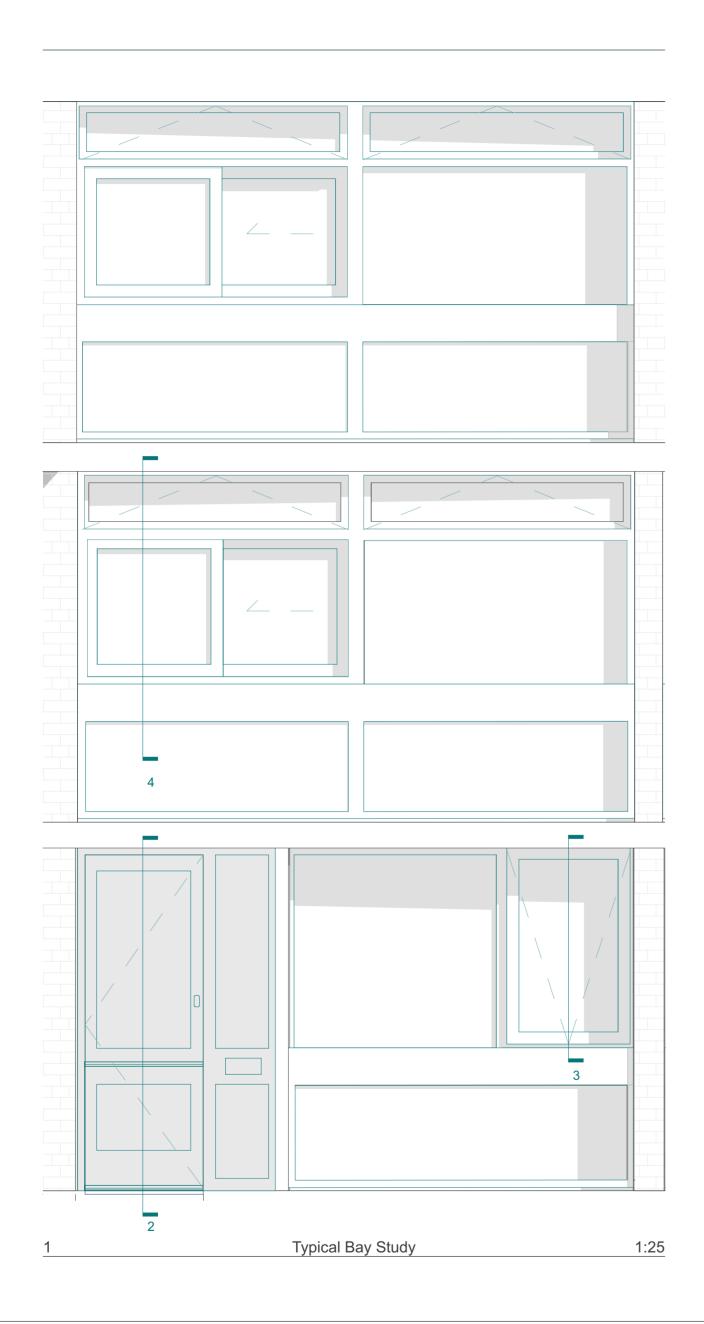

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Rev: Status: Stage 3
Scale: 1:100, 1:10, 102560242212/2023 Rev: Date:

Project: 2203 No80 South Hill Park Client: South Hill Park Drawing: Typical Window Details Drawing no: 2203-3-530