


Left Elevation

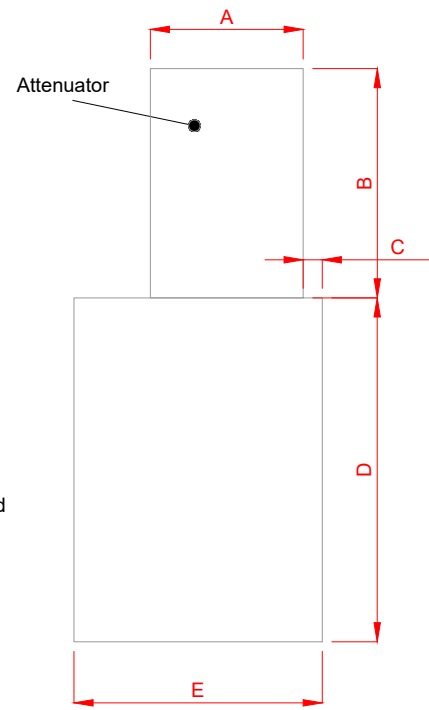


Right Elevation

**Sides**



- 1.2mm Folded galvanised steel frame
- 0.9mm Galvanised perforated sheet steel retaining controlled density mineral wool infill

**Exhaust Air Attenuator**


- 1.2mm Folded galvanised steel frame
- 0.9mm Folded steel splitter sections
- 0.9mm Galvanised perforated sheet steel retaining controlled density mineral wool infill
- Bird guard

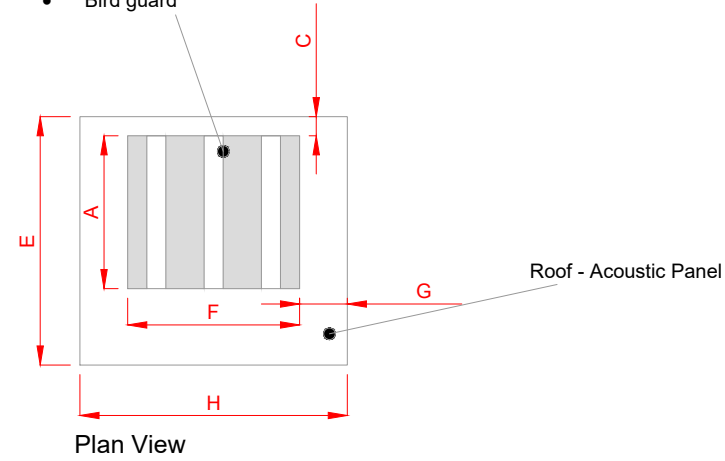

Plan View

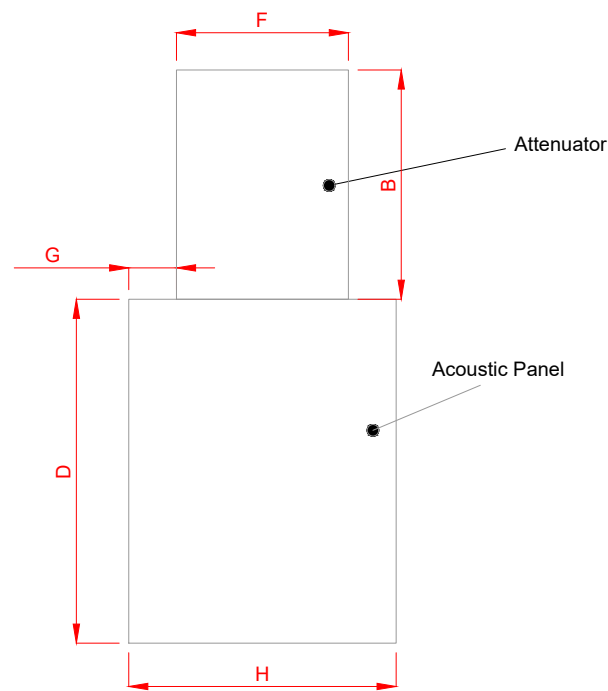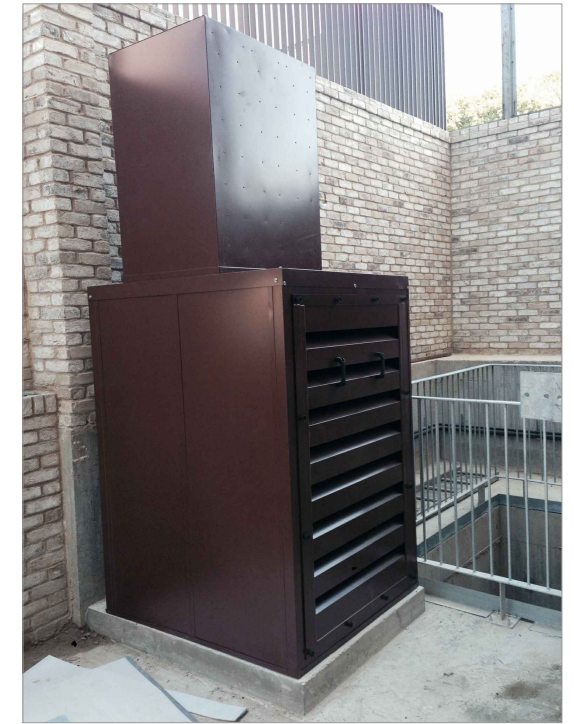


Rear Elevation

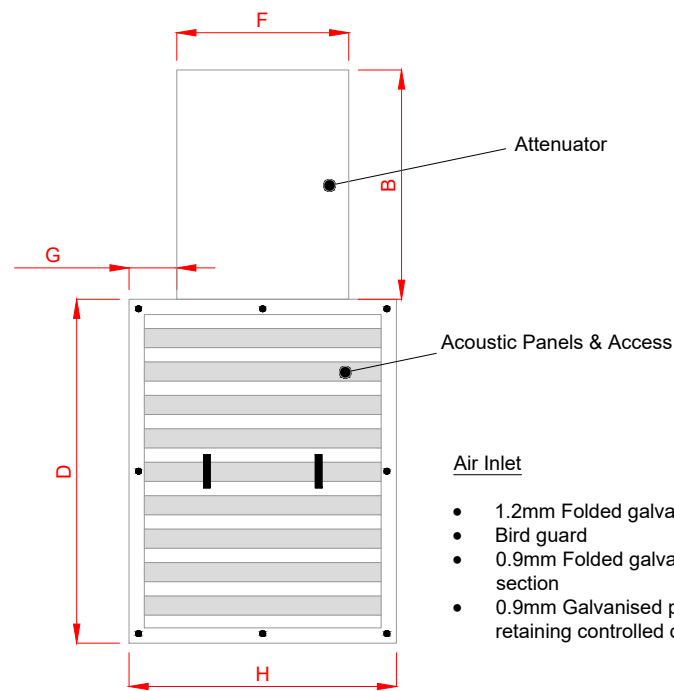

Front Elevation

**Air Inlet**

- 1.2mm Folded galvanised steel frame
- Bird guard
- 0.9mm Folded galvanised sheet steel blade section
- 0.9mm Galvanised perforated sheet steel retaining controlled density mineral wool infill

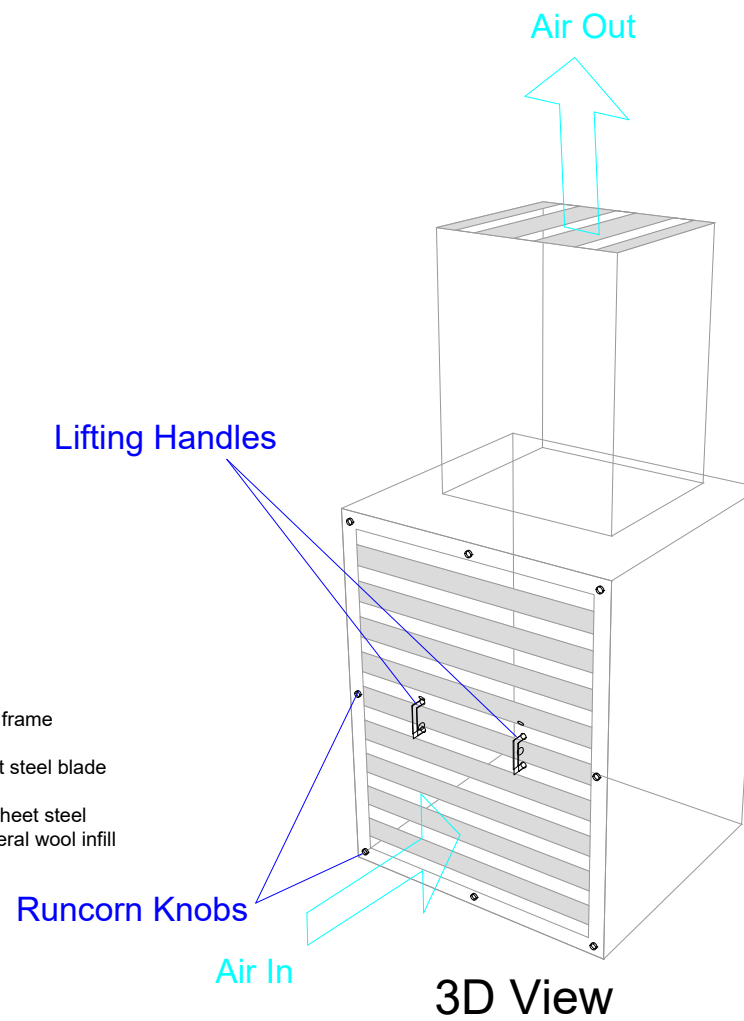

3D View

**Notes**


- Painted in any standard BS or RAL colour
- Installation Services
- Tailored Dimensions
- Insertion Loss 20dB(A)

The field test was carried out in accordance with BS EN ISO 11546-2: 1996 acoustics - Determination of sound insulation performance of enclosures. Part 2 Measurements in situ (for acceptance and verification purposes).

SOUND REDUCTION								
Frequency (Hz)	63	125	250	500	1k	2k	4k	8k
IL (to 1DP) (dB)	13	15.5	19.5	21	18.5	21	22.5	23.5

**Dimensions**

- A \_\_\_\_\_
- B \_\_\_\_\_
- C \_\_\_\_\_
- D \_\_\_\_\_
- E \_\_\_\_\_
- F \_\_\_\_\_
- G \_\_\_\_\_
- H \_\_\_\_\_

Rev	Amendment	Date	Project: Quiet Box V.E.	Scale: N.T.S	Date: 16/11/20	 <p>Sound Planning Limited Farnham Surrey</p> <p>Phone: 01252 711972 Fax: 01252 601083 Email: enquiries@soundplanning.co.uk</p>
Notes No scaling permitted from this drawing. All dimensions shown to be verified prior to construction / manufacture.			Title: Tailored Acoustic Enclosure	Drawn: B.Walker		
				Drawing No: SPqbve01a		